



GOOGONG

LOT 642 GOOGONG

DRAWING NO.	TITLE	RE\
DA0000	LOCATION & DRAWING SCHEDULE	С
DA0001	SITE ANALYSIS & CONTEXT	В
DA0110	SITE PLAN	С
DA0115	MASTER PLAN	С
DA0201	AREA PLAN	В
DA0202	AREA PLAN	В
DA0301	SHADOW DIAGRAM	В
DA0321	SOLAR ACCESS	В
DA0322	SOLAR ACCESS	В
DA0401	PLAN - PEDESTRIAN ACCESS	С
DA1001	FLOOR PLANS - BASEMENT 1	С
DA1002	FLOOR PLANS - LOWER GROUND	С
DA1003	FLOOR PLANS - GROUND	С
DA1004	FLOOR PLANS - LEVEL 1	C
DA1005	FLOOR PLANS - LEVEL 2	C
DA1006	FLOOR PLANS - LEVEL 3	C
DA1007	FLOOR PLANS - LEVEL 4	В
DA1008	FLOOR PLANS - ROOF	В
DA2001	ELEVATIONS - BUILDING A	В
DA2002	ELEVATIONS - BUILDING A	В
DA2003	ELEVATIONS - BUILDING B	В
DA2004	ELEVATIONS - BUILDING C	В
DA2005	ELEVATIONS - BUILDING B & C	В
DA2006	ELEVATIONS - BUILDING D	В
DA2007	ELEVATIONS - BUILDING D	В
DA2007 DA2008	ELEVATIONS - BUILDING E	В
DA2000 DA2009	ELEVATIONS - BUILDING F	В
DA2009 DA2010	ELEVATIONS - BOILDING F ELEVATIONS - COMMUNAL LOUNGE	ь
DA2101	ELEVATIONS - COMPOSITE STREETSCAPE	В
DA2101 DA2102	ELEVATIONS - COMPOSITE STREETSCAPE	В
DA3001	SECTIONS - OVERALL	С
DA3001 DA3002	SECTIONS - OVERALL SECTIONS - OVERALL	В
DA4001	UNIT TYPE PLANS - BUILDING A	C
DA4001 DA4002	UNIT TYPE PLANS - BUILDING A UNIT TYPE PLANS - BUILDING B / C & D	C
DA4002 DA4003	UNIT TYPE PLANS - BUILDING B / C & D	C
DA4003 DA4004	UNIT TYPE PLANS - BOILDING E & F UNIT TYPE PLANS - ADAPTABLE	C
		В
DA5001	MATERIALS & FINISHES	_
DA7001	DETAIL - WASTE ENCLOSURE	В
DA7002	DETAIL - MAILBOXES, COURTYARDS & FENCING	В
DA7003	DETAIL - POOL FENCING	A
DA8001	PERSPECTIVE	В
DA8002	PERSPECTIVE	В
DA8003	PERSPECTIVE	В
DA8004	PERSPECTIVE	В

LOT 642 GOOGONG

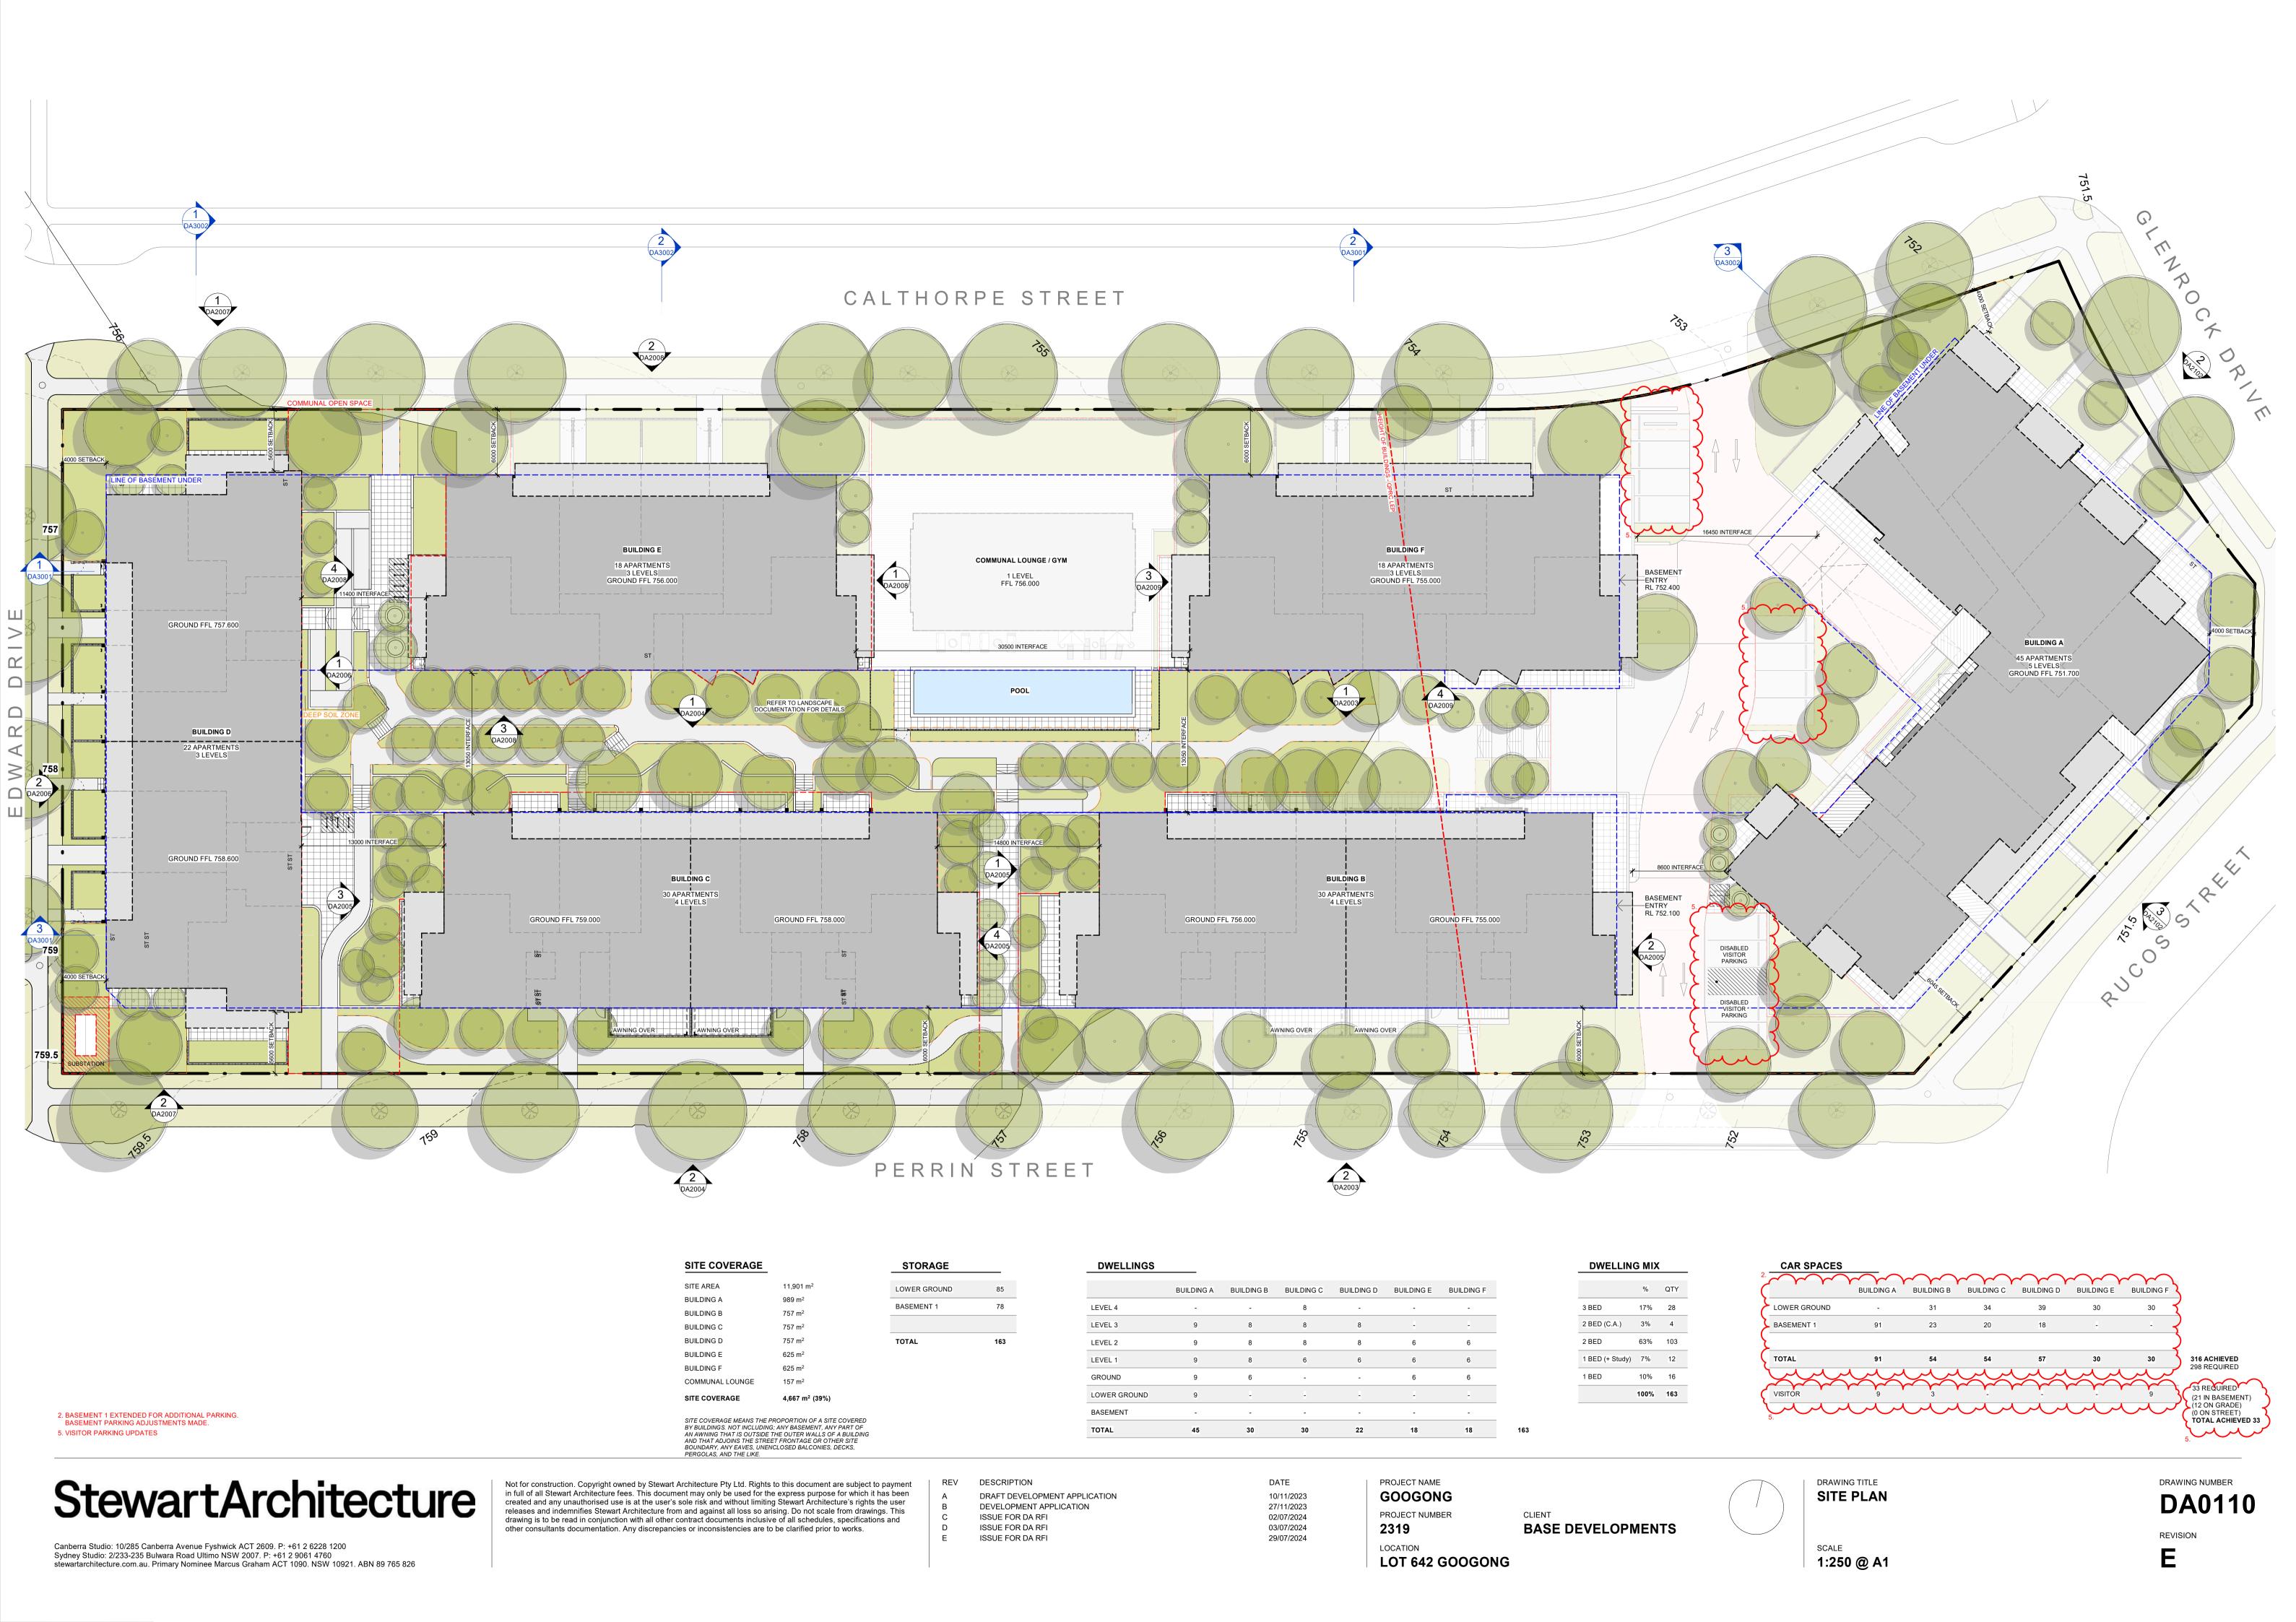

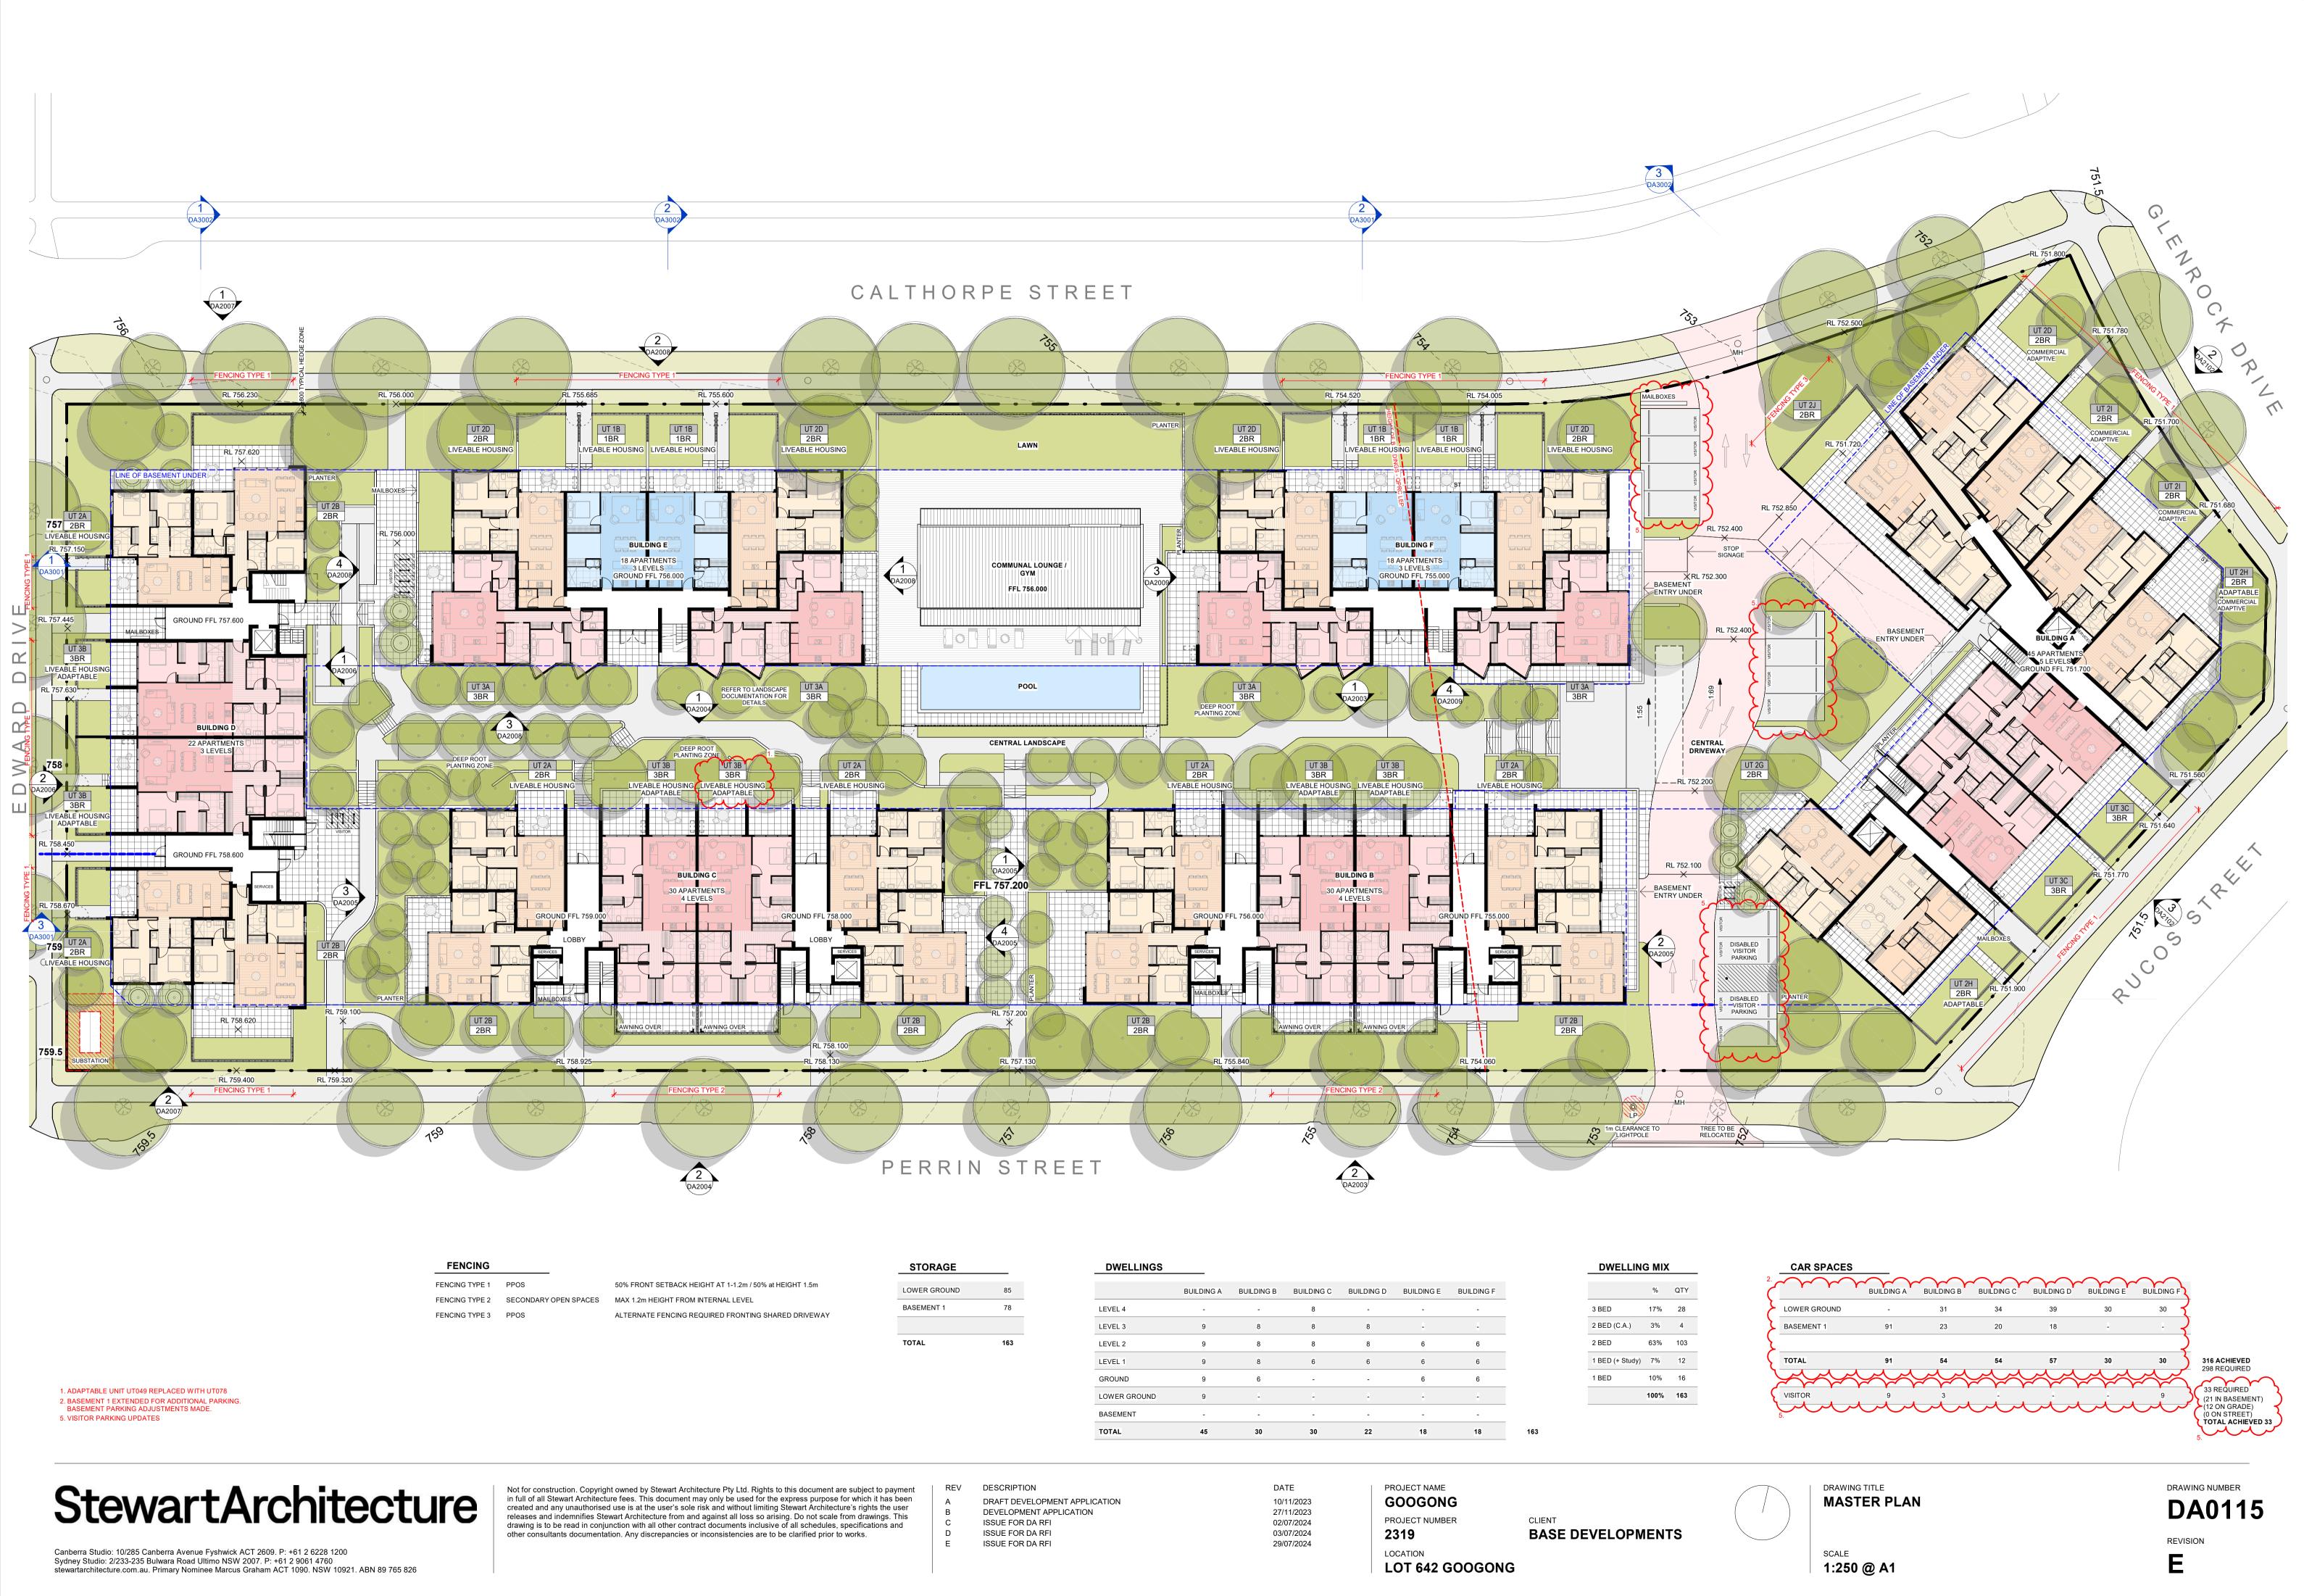





AREA LEVEL 1 AREA LEVEL 2

10/11/2023

27/11/2023



AREA LEVEL 4 AREA LEVEL 3

GROSS FLOOR AREA

THE SUM OF THE FLOOR AREA OF EACH FLOOR OF A BUILDING MEASURED FROM THE INTERNAL FACE OF EXTERNAL WALLS, OR FROM THE INTERNAL FACE OF WALLS SEPERATING THE BUILDING FROM ANY OTHER BUILDING, MEASURED AT A HEIGHT OF 1.4 METERS ABOVE THE FLOOR, AND INCLUDES:

(A) THE AREA OF A MEZZANINE, AND

(B) HABITABLE ROOMS IN A BASEMENT OR AN ATTIC AND (C) ANY SHOP, AUDITORIUM, CINEMA, AND THE LIKE, IN A BASEMENT OR ATTIC,

BUT EXCLUDES:

(D) ANY AREA FOR COMMON VERTICAL CIRCULATION, SUCH AS LIFTS ÀND STAIRS AND

(E) ANY BASEMENT

(II) VEHICULAR ACCESS, LOADING AREAS, GARBAGE AND SERVICES, AND

(F) PLANT ROOMS, LIFT TOWERS AND OTHER AREAS USED EXCLUSIVELY FOR MECHANICAL SERVICES OR DUCTING AND

(G) CAR PARKING TO MEET ANY REQUIREMENTS OF THE CONSENT AUTHORITY (INCLUDING ACCESS TO THAT CAR PARKING), AND

(H) ANY SPACE USED FOR THE LOADING OR UNLOADING OF GOODS (INCLUDING ACCESS TO IT), AND

(I) TERRACES AND BALCONIES WITH OUTER WALLS LESS THAN 1.4 METES HIGH, AND

(J) VOIDS ABOVE A FLOOR AT THE LEVEL OF A STOREY OR STOREY ABOVE.

DEFINITION AS PER QUEANBEYAN LEP

SITE AREA (AS PER SURVEYED BOUNDARY):

PERMISSABLE FSR (LEP)

EAST (MAXIMUM RATIO 2:1)

EAST SITE AREA: TOTAL EAST FSR:

APARTMENTS


GROUND FLOOR: UPPER GROUND: LEVEL 1: LEVEL 2: LEVEL 3: LEVEL 4: 828m² 2 439m² 3 638m² 3 744m² 2 684m² 626m²

13 959m² TOTAL GFA:


BUILDING BREAKDOWN

GROUND FLOOR: (A) 828m²
UPPER GROUND: (E) 530m² (F) 530m² (B) 573m² (A) 806m²
LEVEL 1:(E) 530m² (F) 530m² (D) 573m² (C) 573m² (B) 626m² (A) 806m²
LEVEL 2:(E) 530m² (F) 530m² (D) 626m² (C) 626m² (B) 626m² (A) 806m²
LEVEL 3:(D) 626m² (C) 626m² (B) 626m² (A) 806m²
LEVEL 4:(C) 626m²



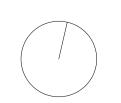

2319

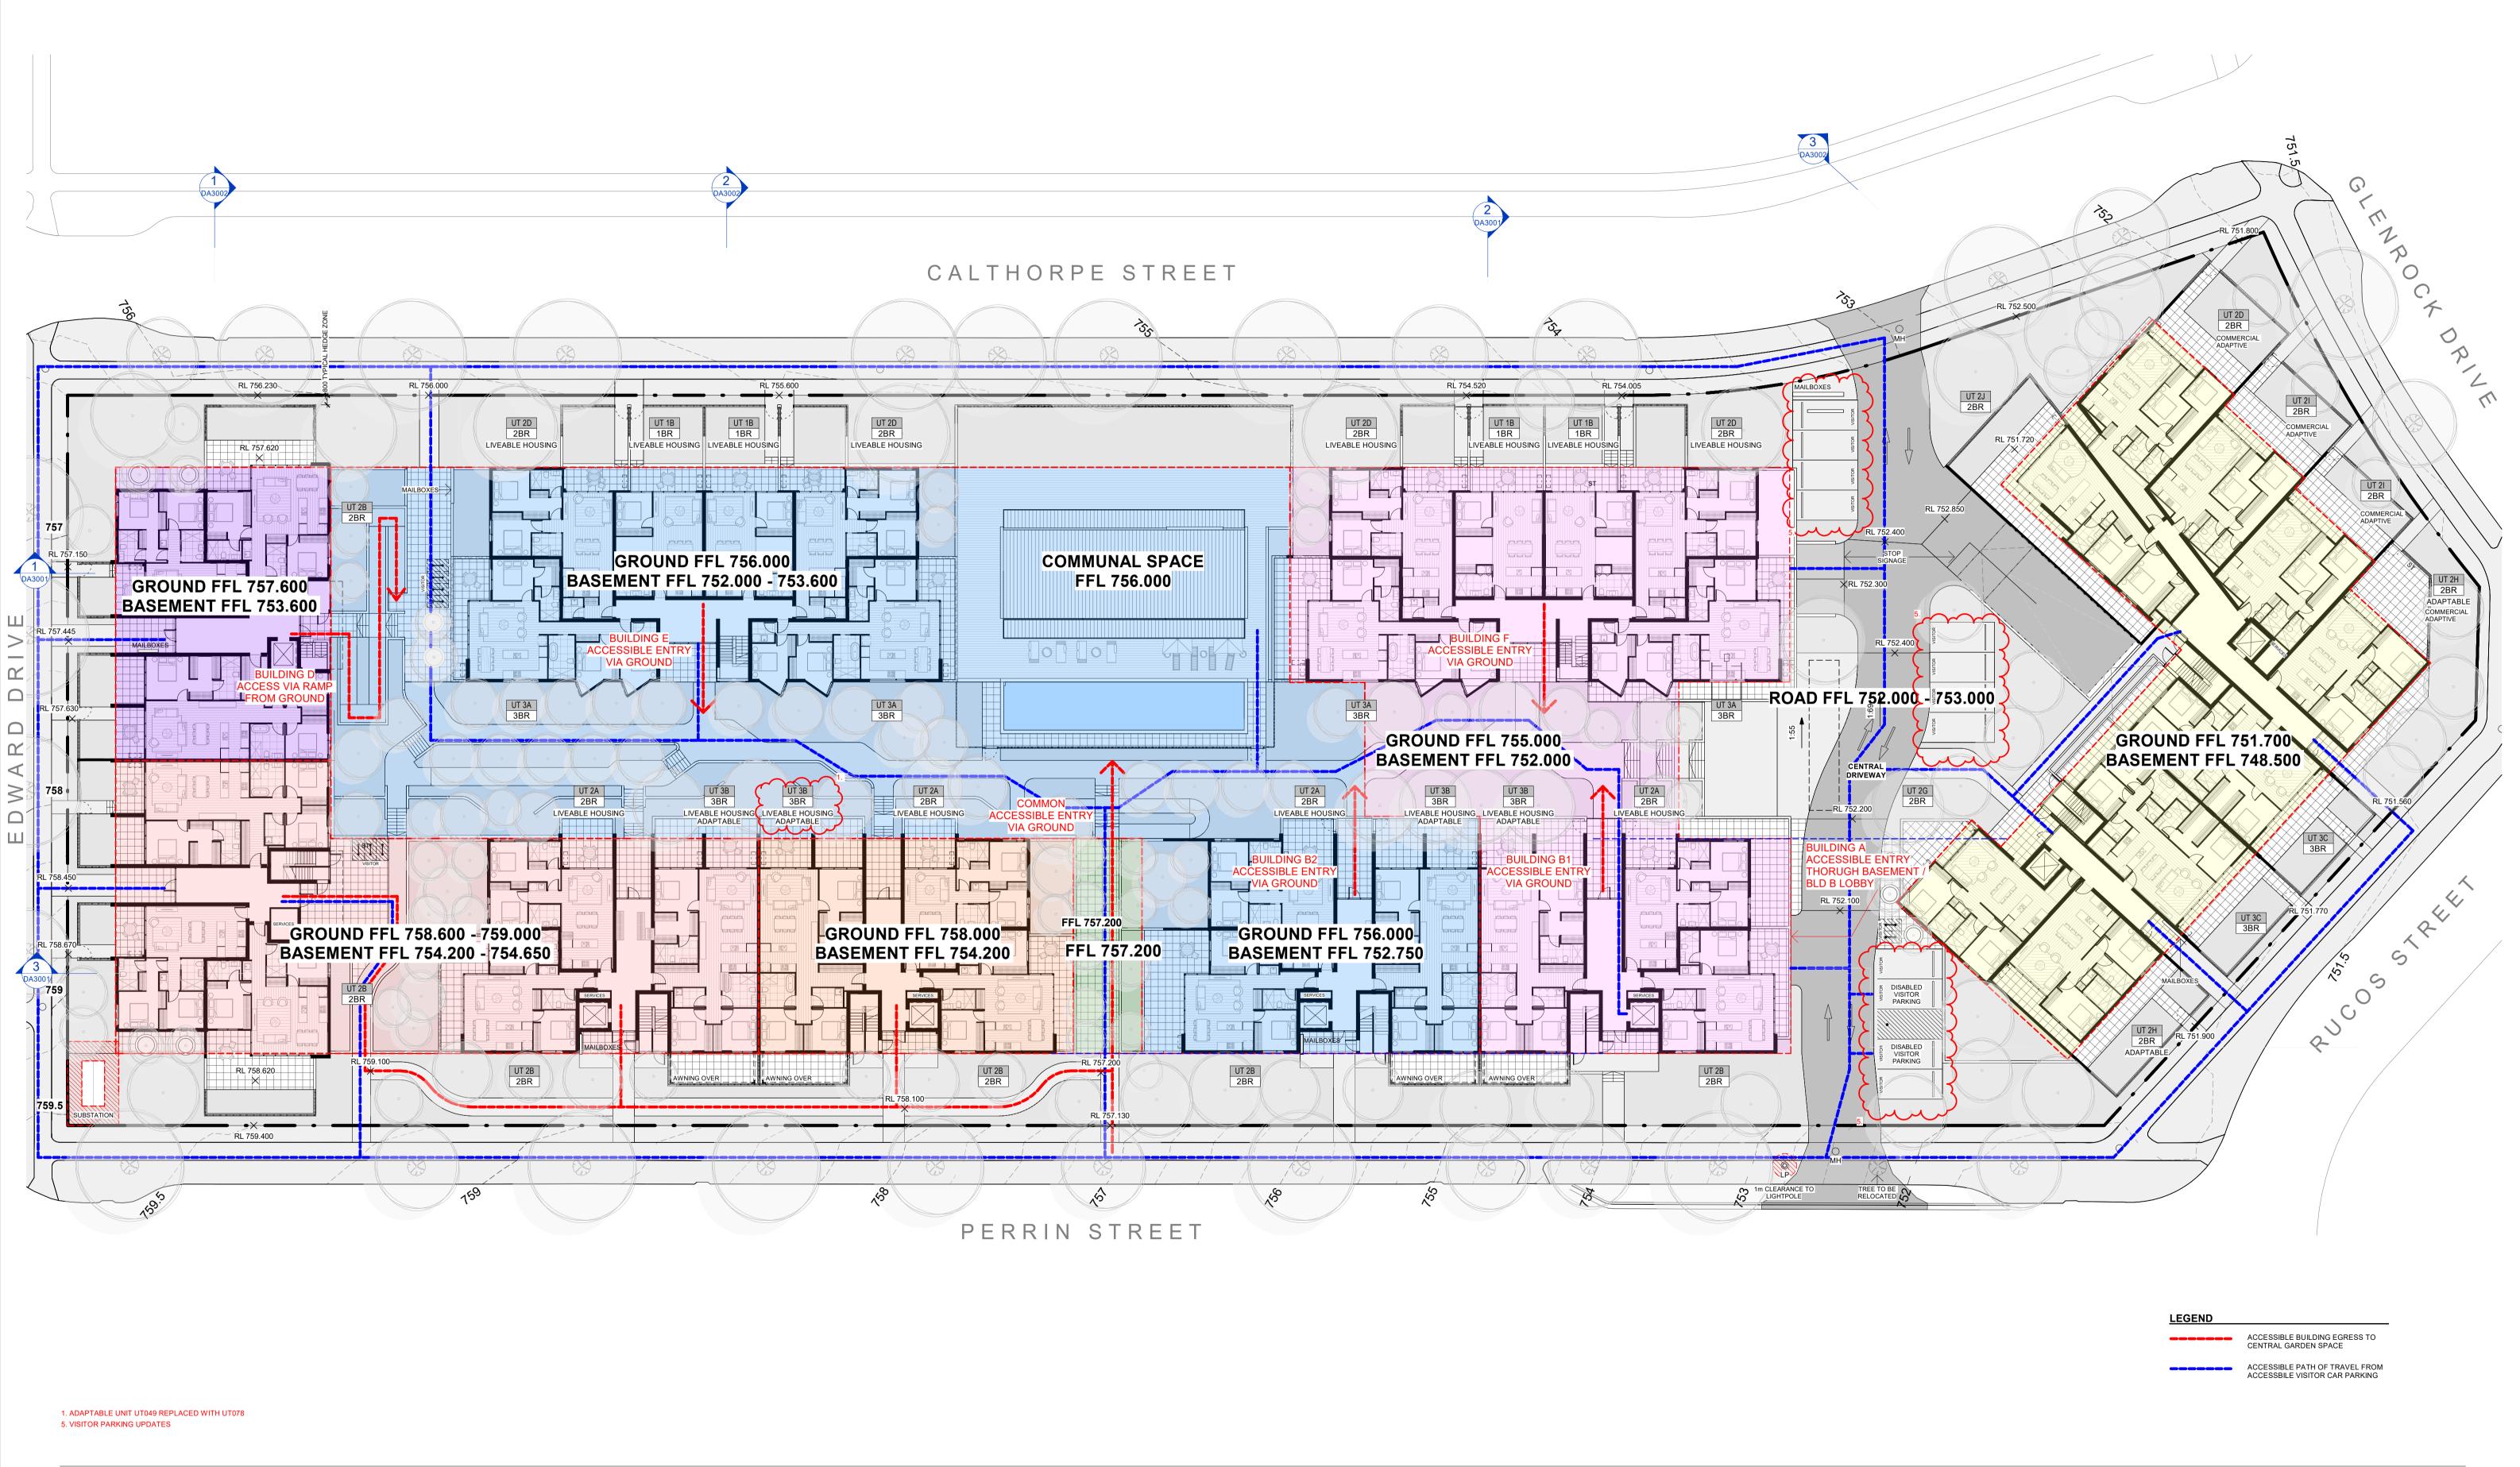

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DRAFT DEVELOPMENT APPLICATION DEVELOPMENT APPLICATION ISSUE FOR DA RFI ISSUE FOR DA RFI ISSUE FOR DA RFI


10/11/2023 27/11/2023 02/07/2024 03/07/2024 29/07/2024

PROJECT NAME GOOGONG PROJECT NUMBER **BASE DEVELOPMENTS** 2319




PLAN - PEDESTRIAN ACCESS

DRAWING NUMBER **DA0401**

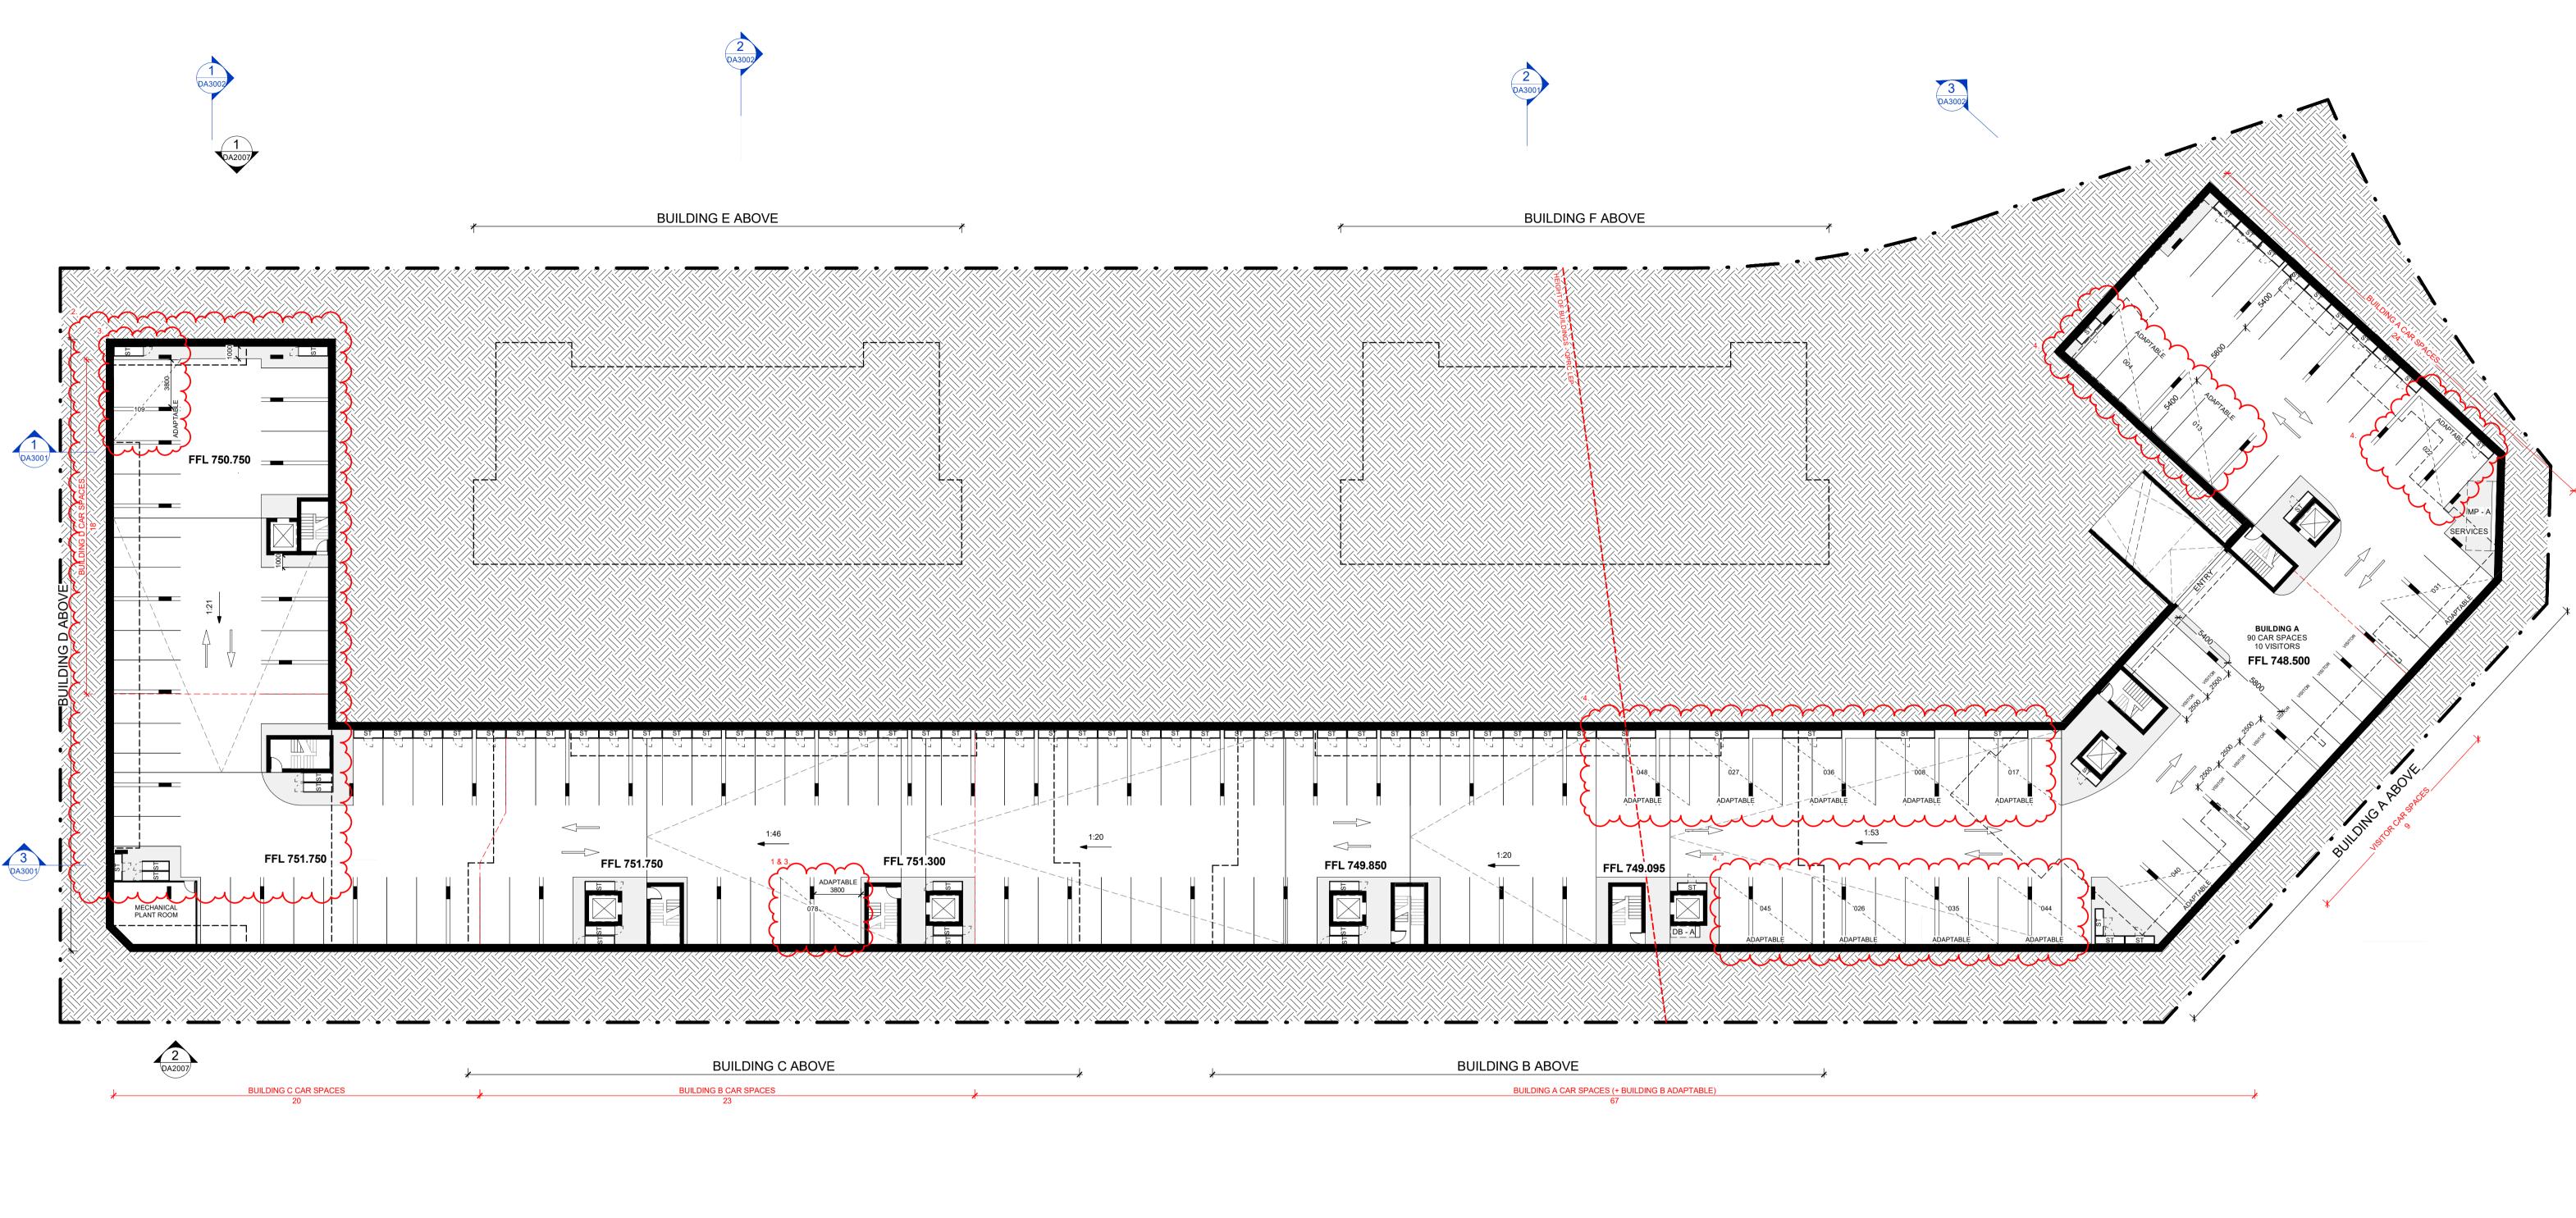


DWELLINGS

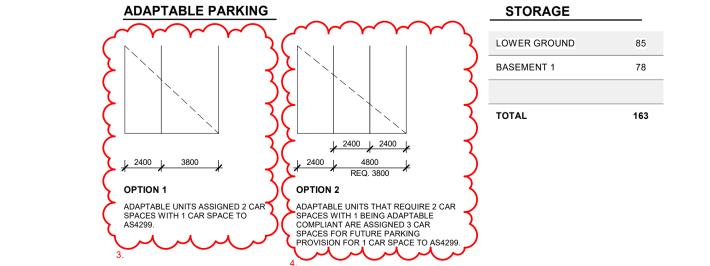

	BUILDING A	BUILDING B	BUILDING C	BUILDING D	BUILDING E	BUILDIN
LEVEL 4	-	-	8	-	-	-
LEVEL 3	9	8	8	8	-	-
LEVEL 2	9	8	8	8	6	6
LEVEL 1	9	8	6	6	6	6
GROUND	9	6	-	-	6	6
LOWER GROUND	9	-	-	-	-	-
BASEMENT	-	-	-	-	-	-
TOTAL	45	30	30	22	18	18

DWELLING MIX			
	%	QTY	
3 BED	17%	28	
2 BED (C.A.)	3%	4	
2 BED	63%	103	
1 BED (+ Study)	7%	12	
1 BED	10%	16	
	100%	163	

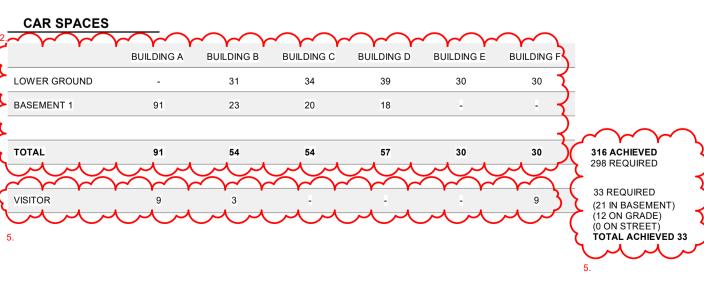

1. ADAPTABLE UNIT UT049 REPLACED WITH UT078
2. BASEMENT 1 EXTENDED FOR ADDITIONAL PARKING.
BASEMENT PARKING ADJUSTMENTS MADE.
3. ADAPTABLE PARKING OPTION 1
4. ADAPTABLE PARKING OPTION 2
5. VISITOR PARKING UPDATES

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REV DESCRIPTION

A DRAFT DEVELOPMENT APPLICATION

B DEVELOPMENT APPLICATION

C ISSUE FOR DA RFI

D ISSUE FOR DA RFI

DATE 10/11/2023 27/11/2023 02/07/2024 29/07/2024 PROJECT NAME
GOOGONG
PROJECT NUMBER
CLIENT
BASE DEVELOPMENTS
LOCATION
LOT 642 GOOGONG




DRAWING TITLE
FLOOR PLANS - BASEMENT 1


1:250 @ A1

NS - BASEMENT 1

DA1001

REVISION

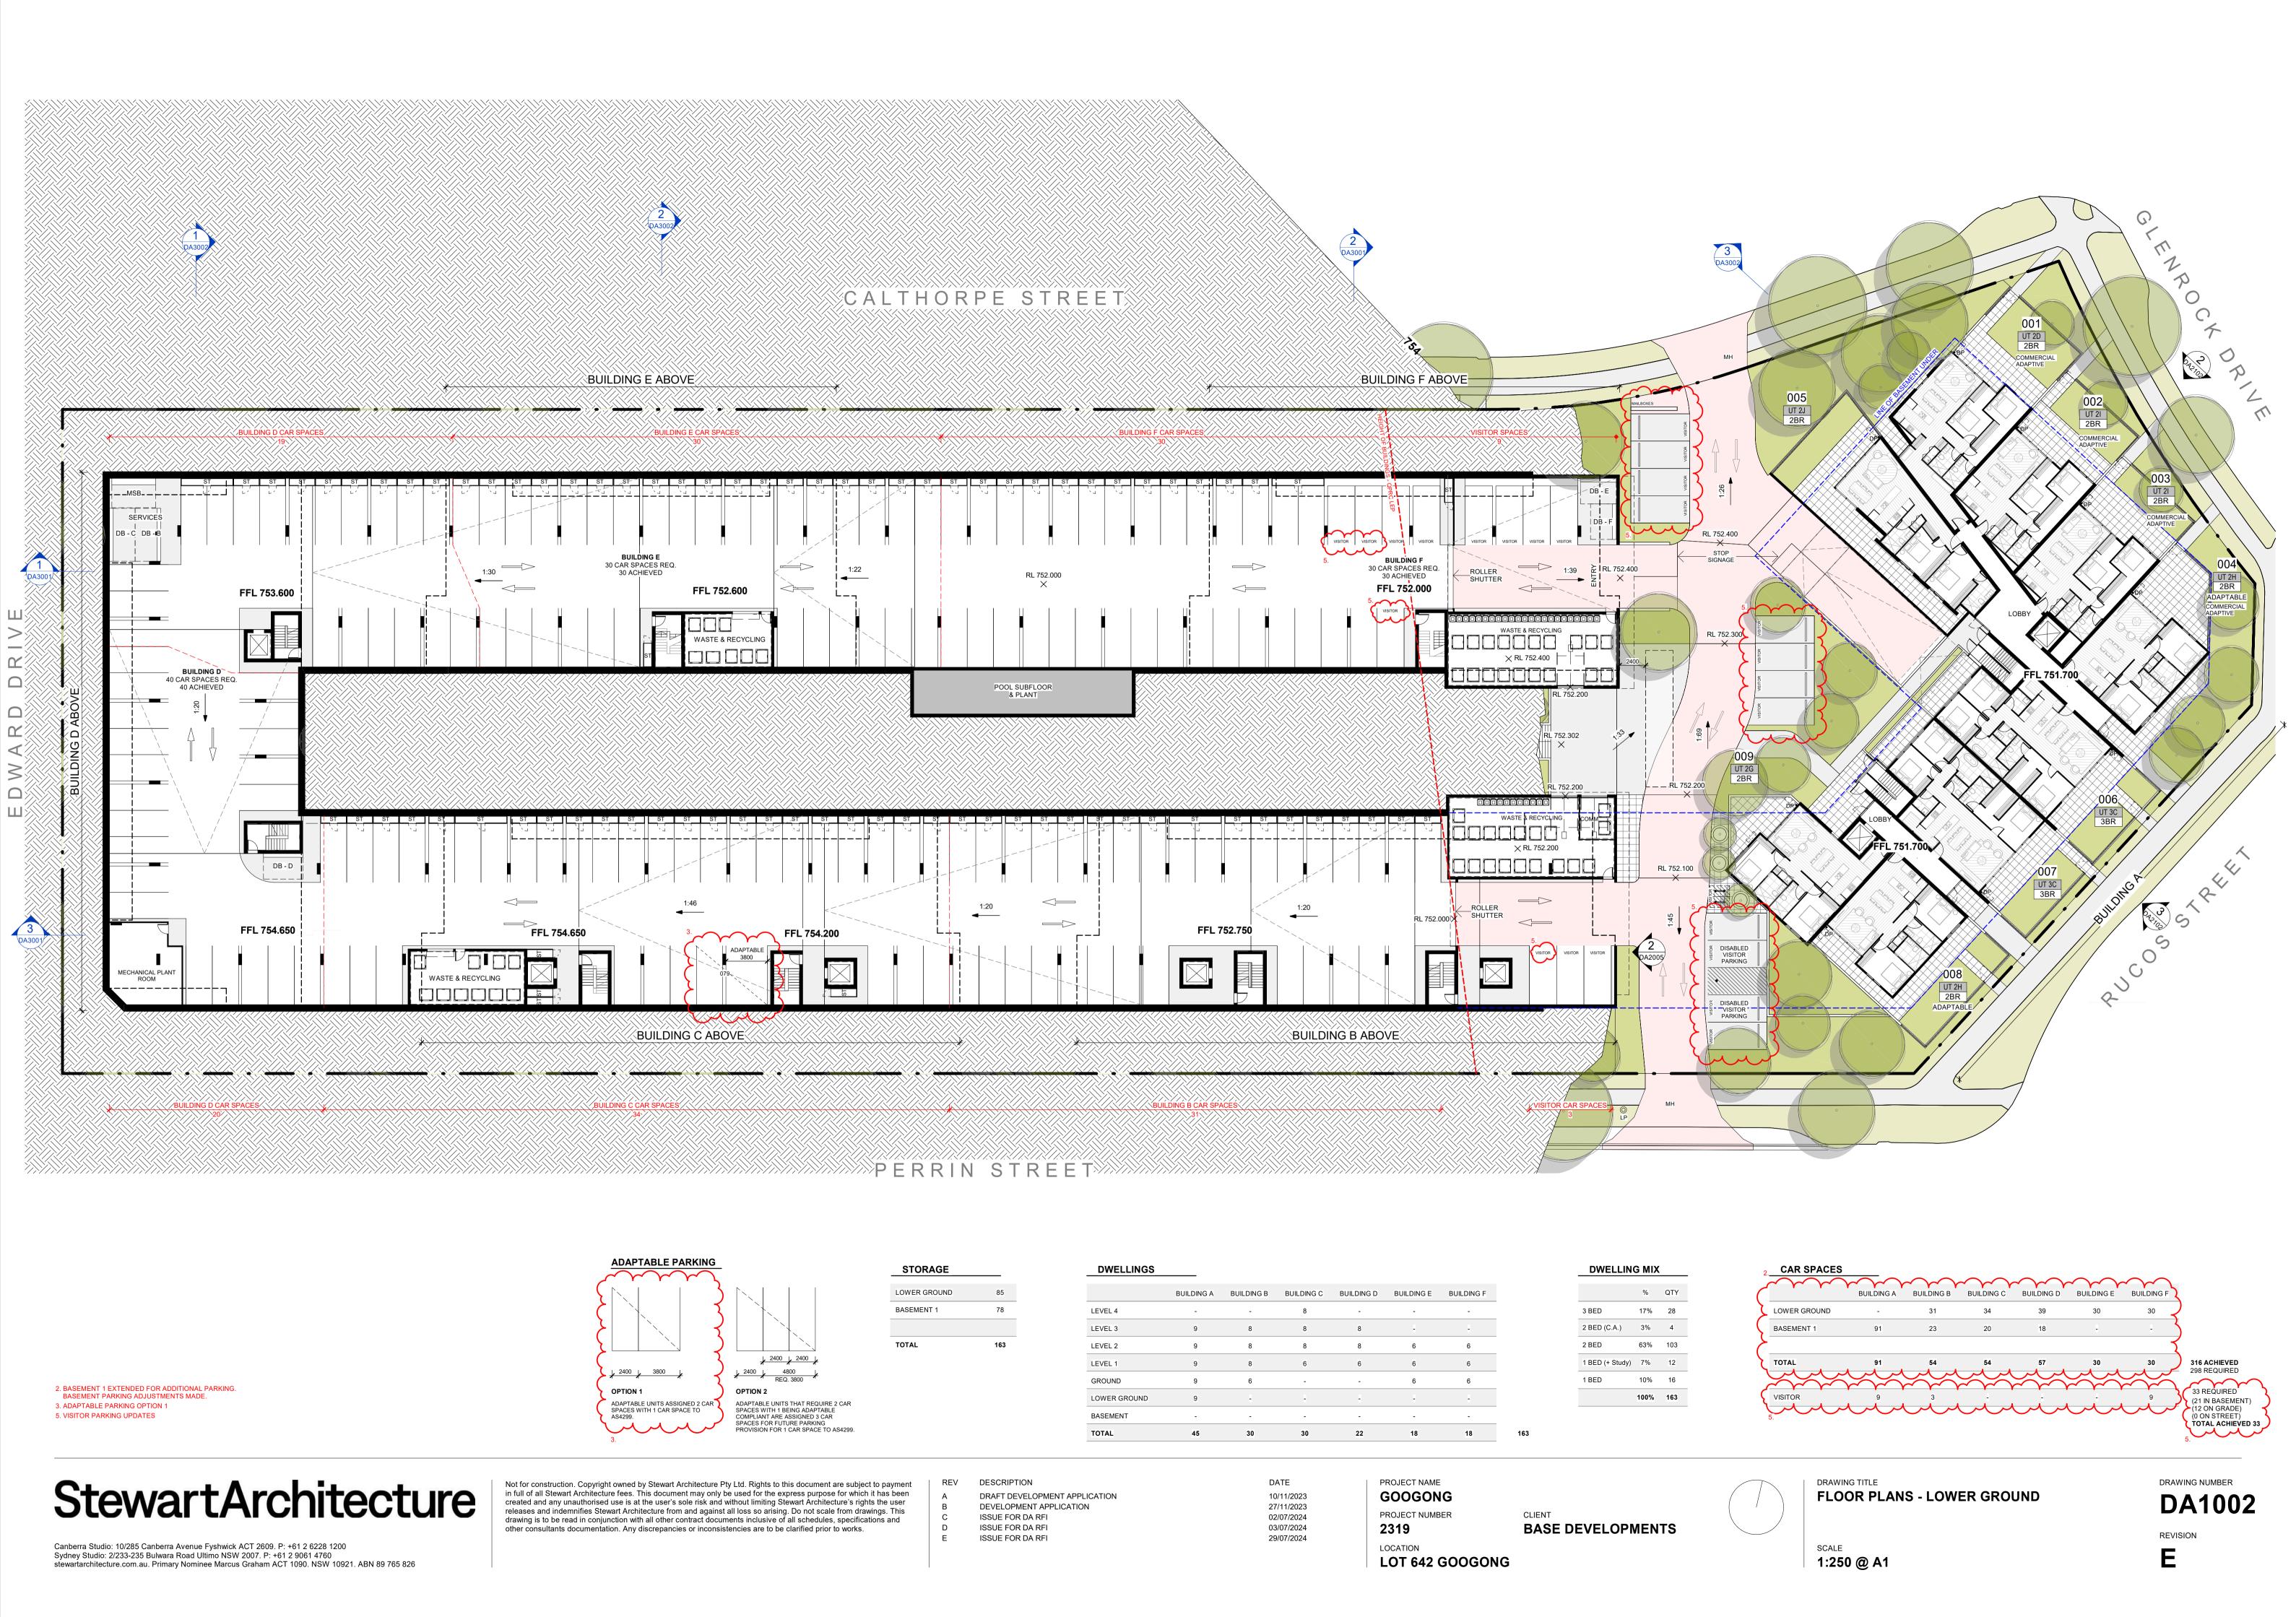

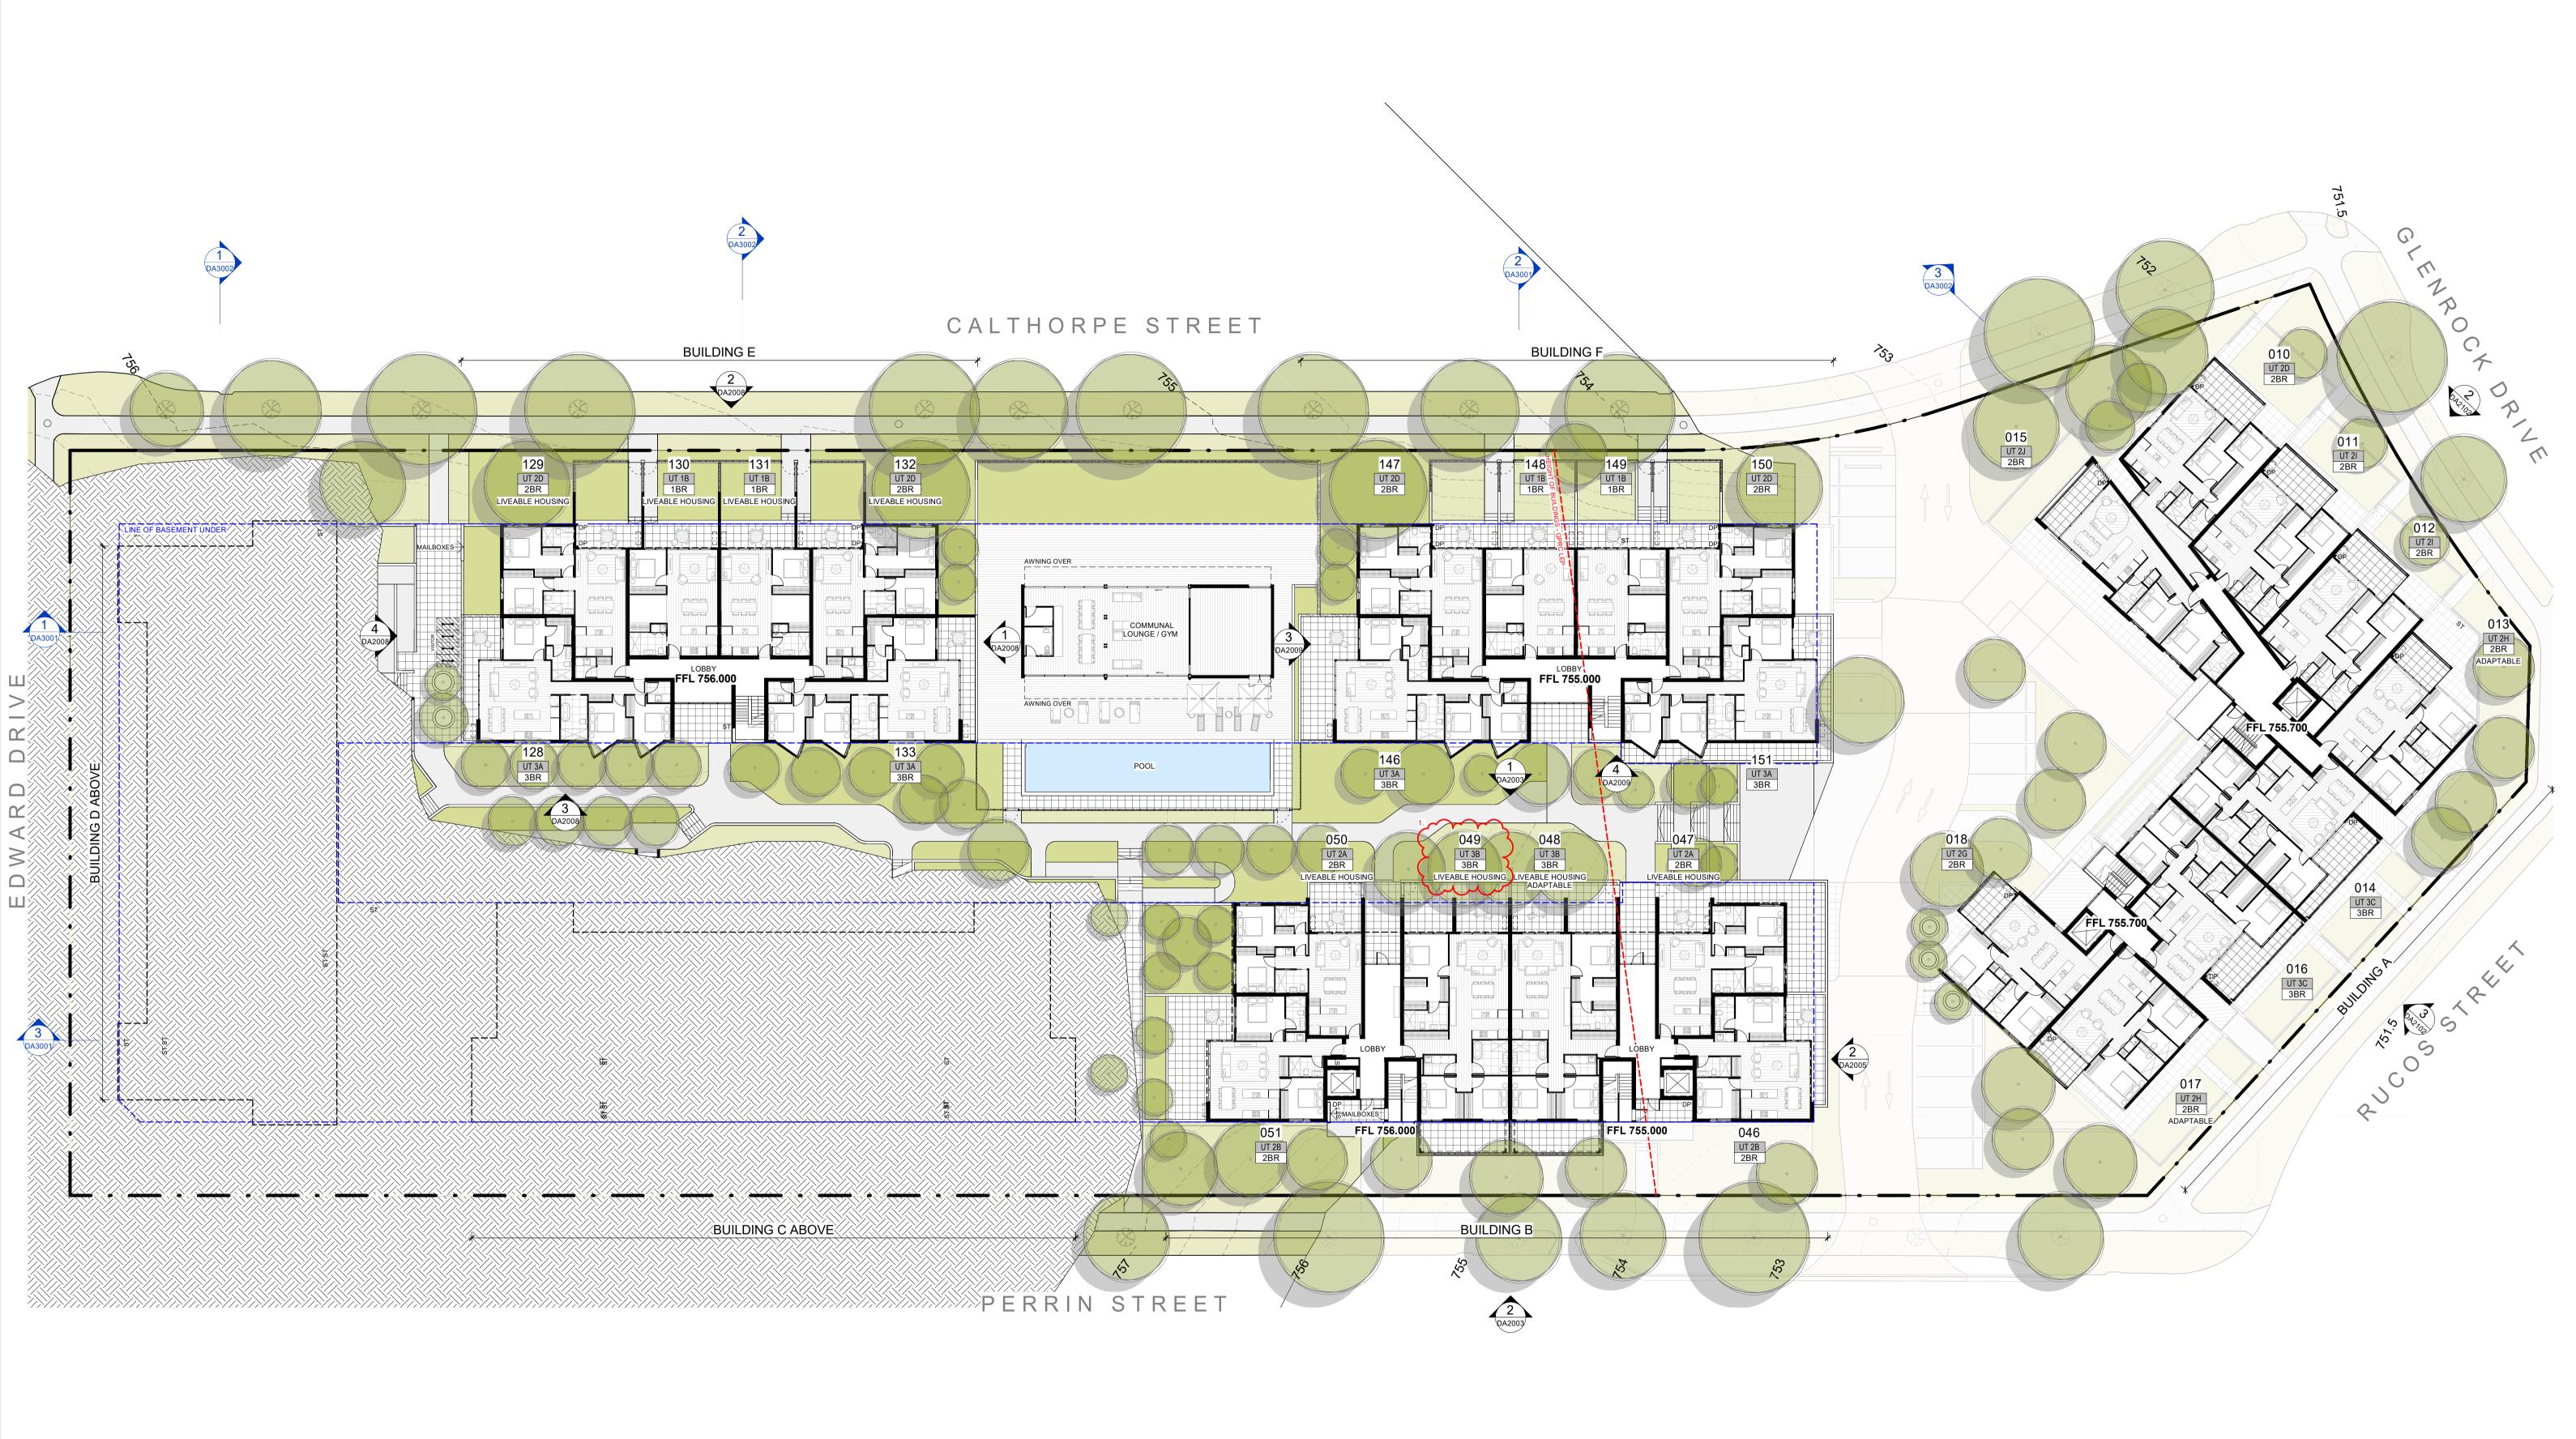

1. ADAPTABLE UNIT UT049 REPLACED WITH UT078

DRAFT DEVELOPMENT APPLICATION DEVELOPMENT APPLICATION ISSUE FOR DA RFI ISSUE FOR DA RFI

10/11/2023 27/11/2023 02/07/2024 03/07/2024 29/07/2024

PROJECT NAME GOOGONG PROJECT NUMBER **BASE DEVELOPMENTS** 2319 LOCATION

LOT 642 GOOGONG



FLOOR PLANS - GROUND

DRAWING NUMBER **DA1003**




LOT 642 GOOGONG



FLOOR PLANS - LEVEL 1

DRAWING NUMBER **DA1004**

1. ADAPTABLE UNIT UT049 REPLACED WITH UT078

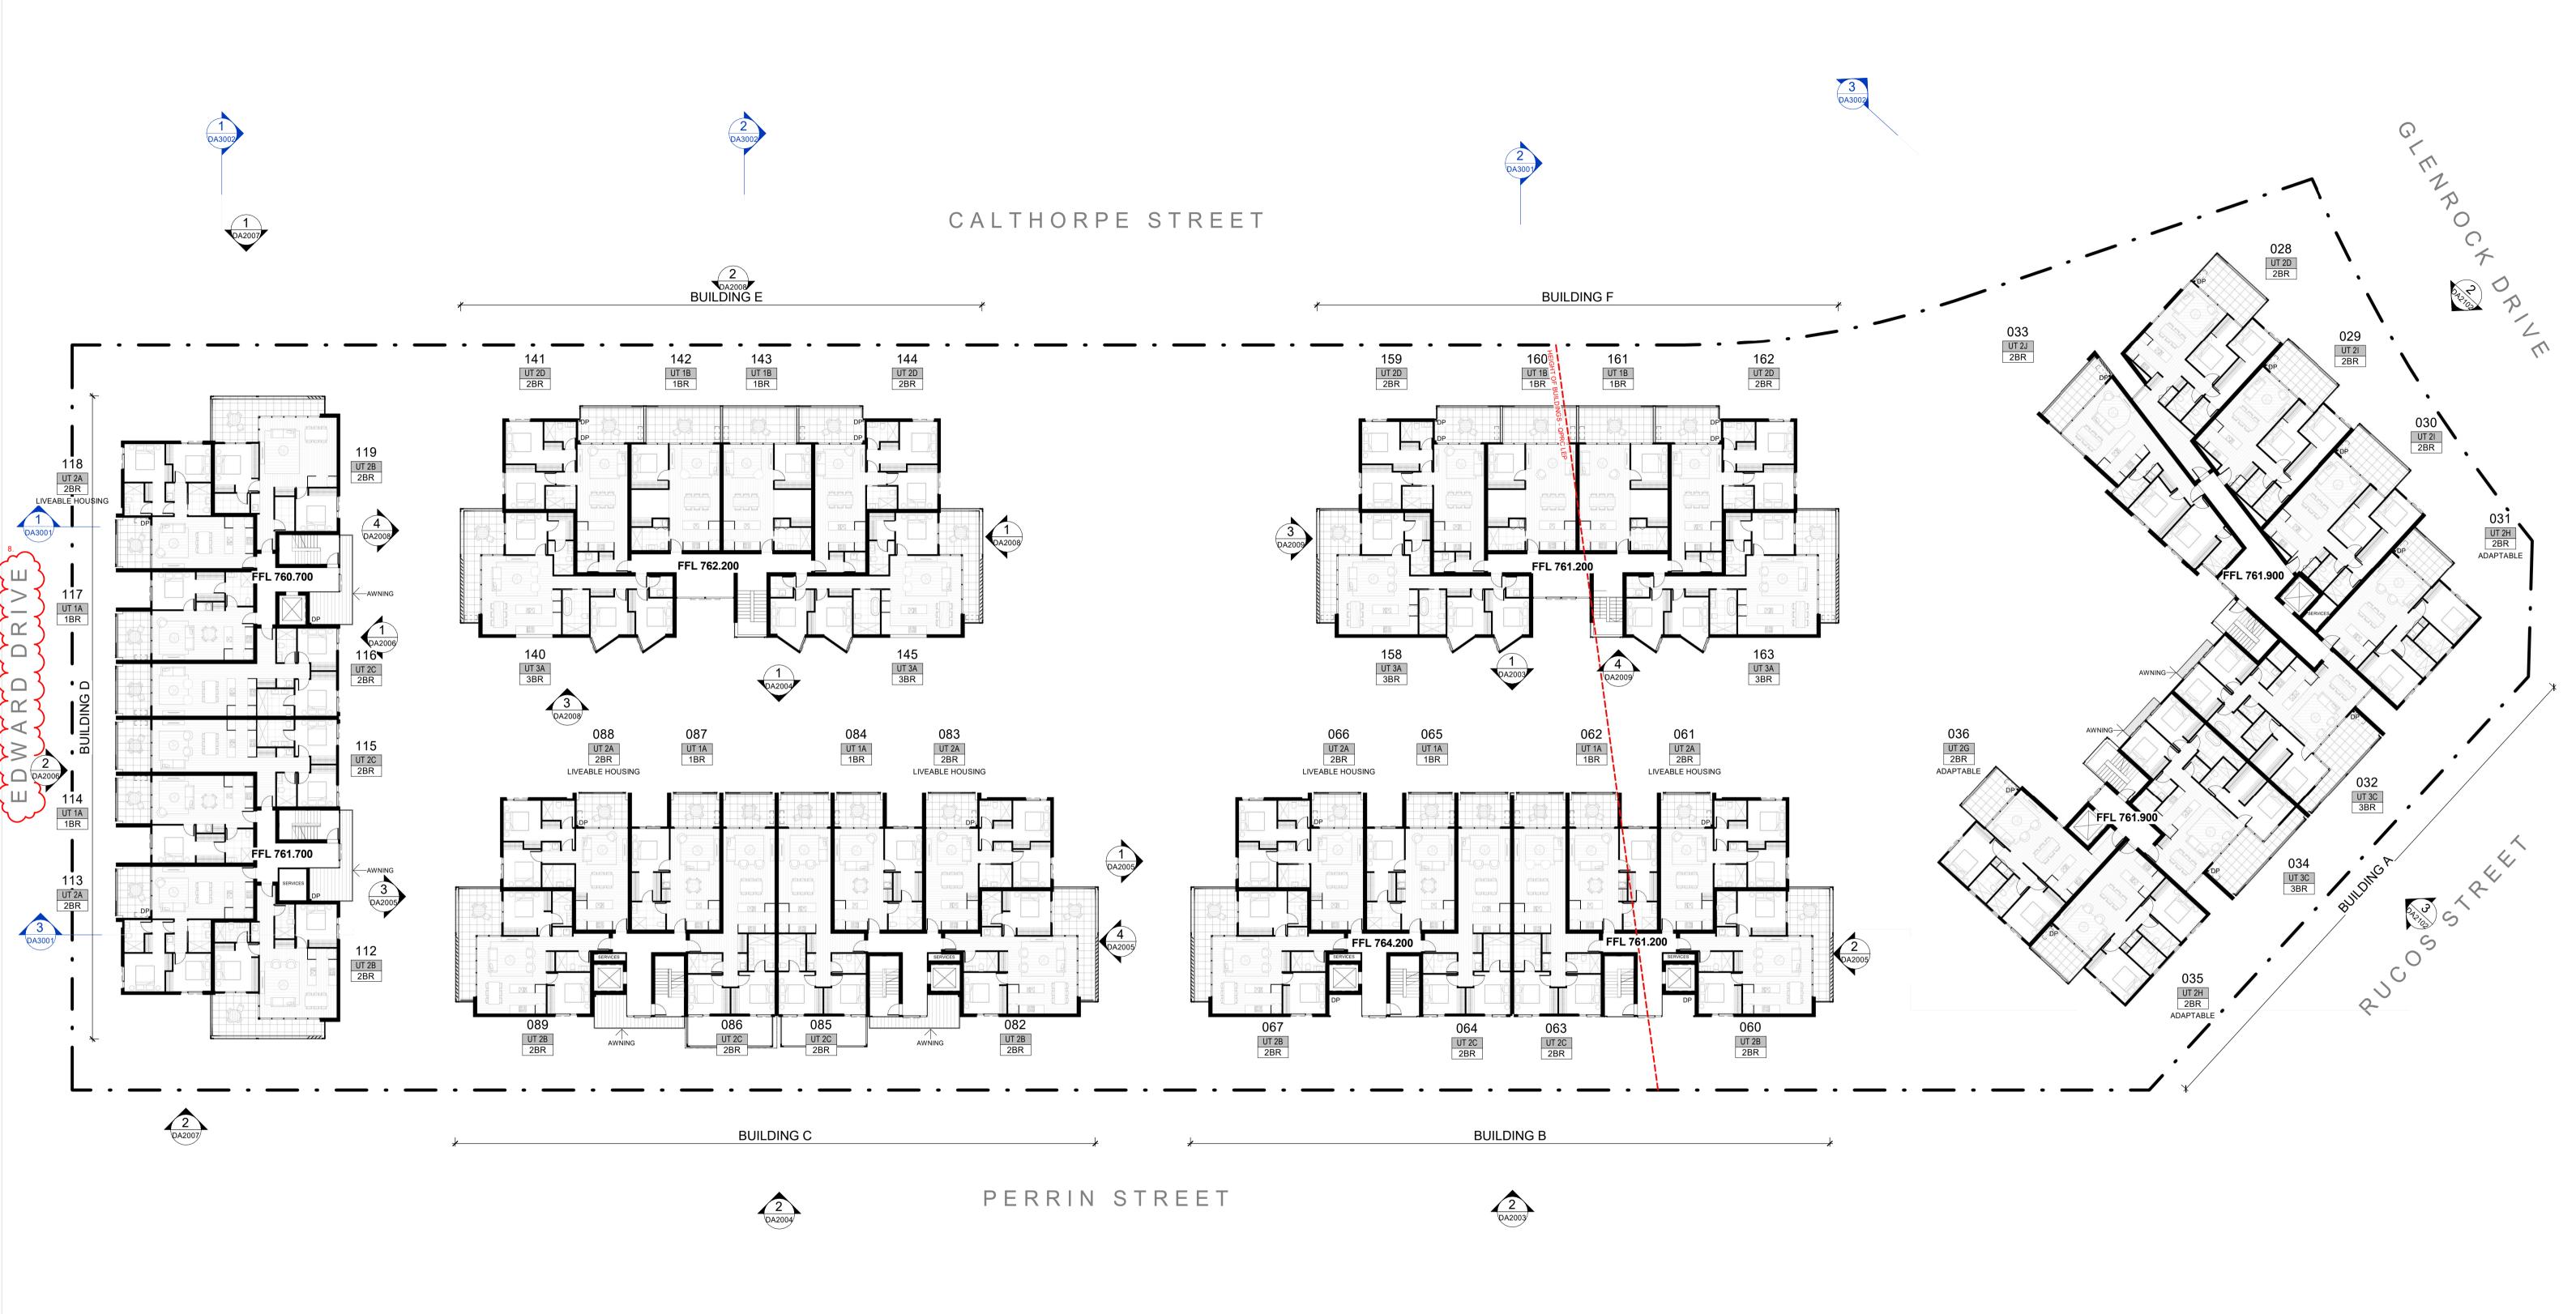

REV DESCRIPTION

A DRAFT DEVELOPMENT APPLICATION

B DEVELOPMENT APPLICATION


C ISSUE FOR DA RFI

DATE 10/11/2023 27/11/2023 02/07/2024

LOCATION

LOT 642 GOOGONG

PROJECT NAME
GOOGONG
PROJECT NUMBER
CLIENT
BASE DEVELOPMENTS

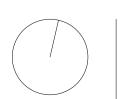


DRAWING TITLE
FLOOR PLANS - LEVEL 2


DA1005

REVISION

8. PLAN INCLUSIONS AND ERRORS

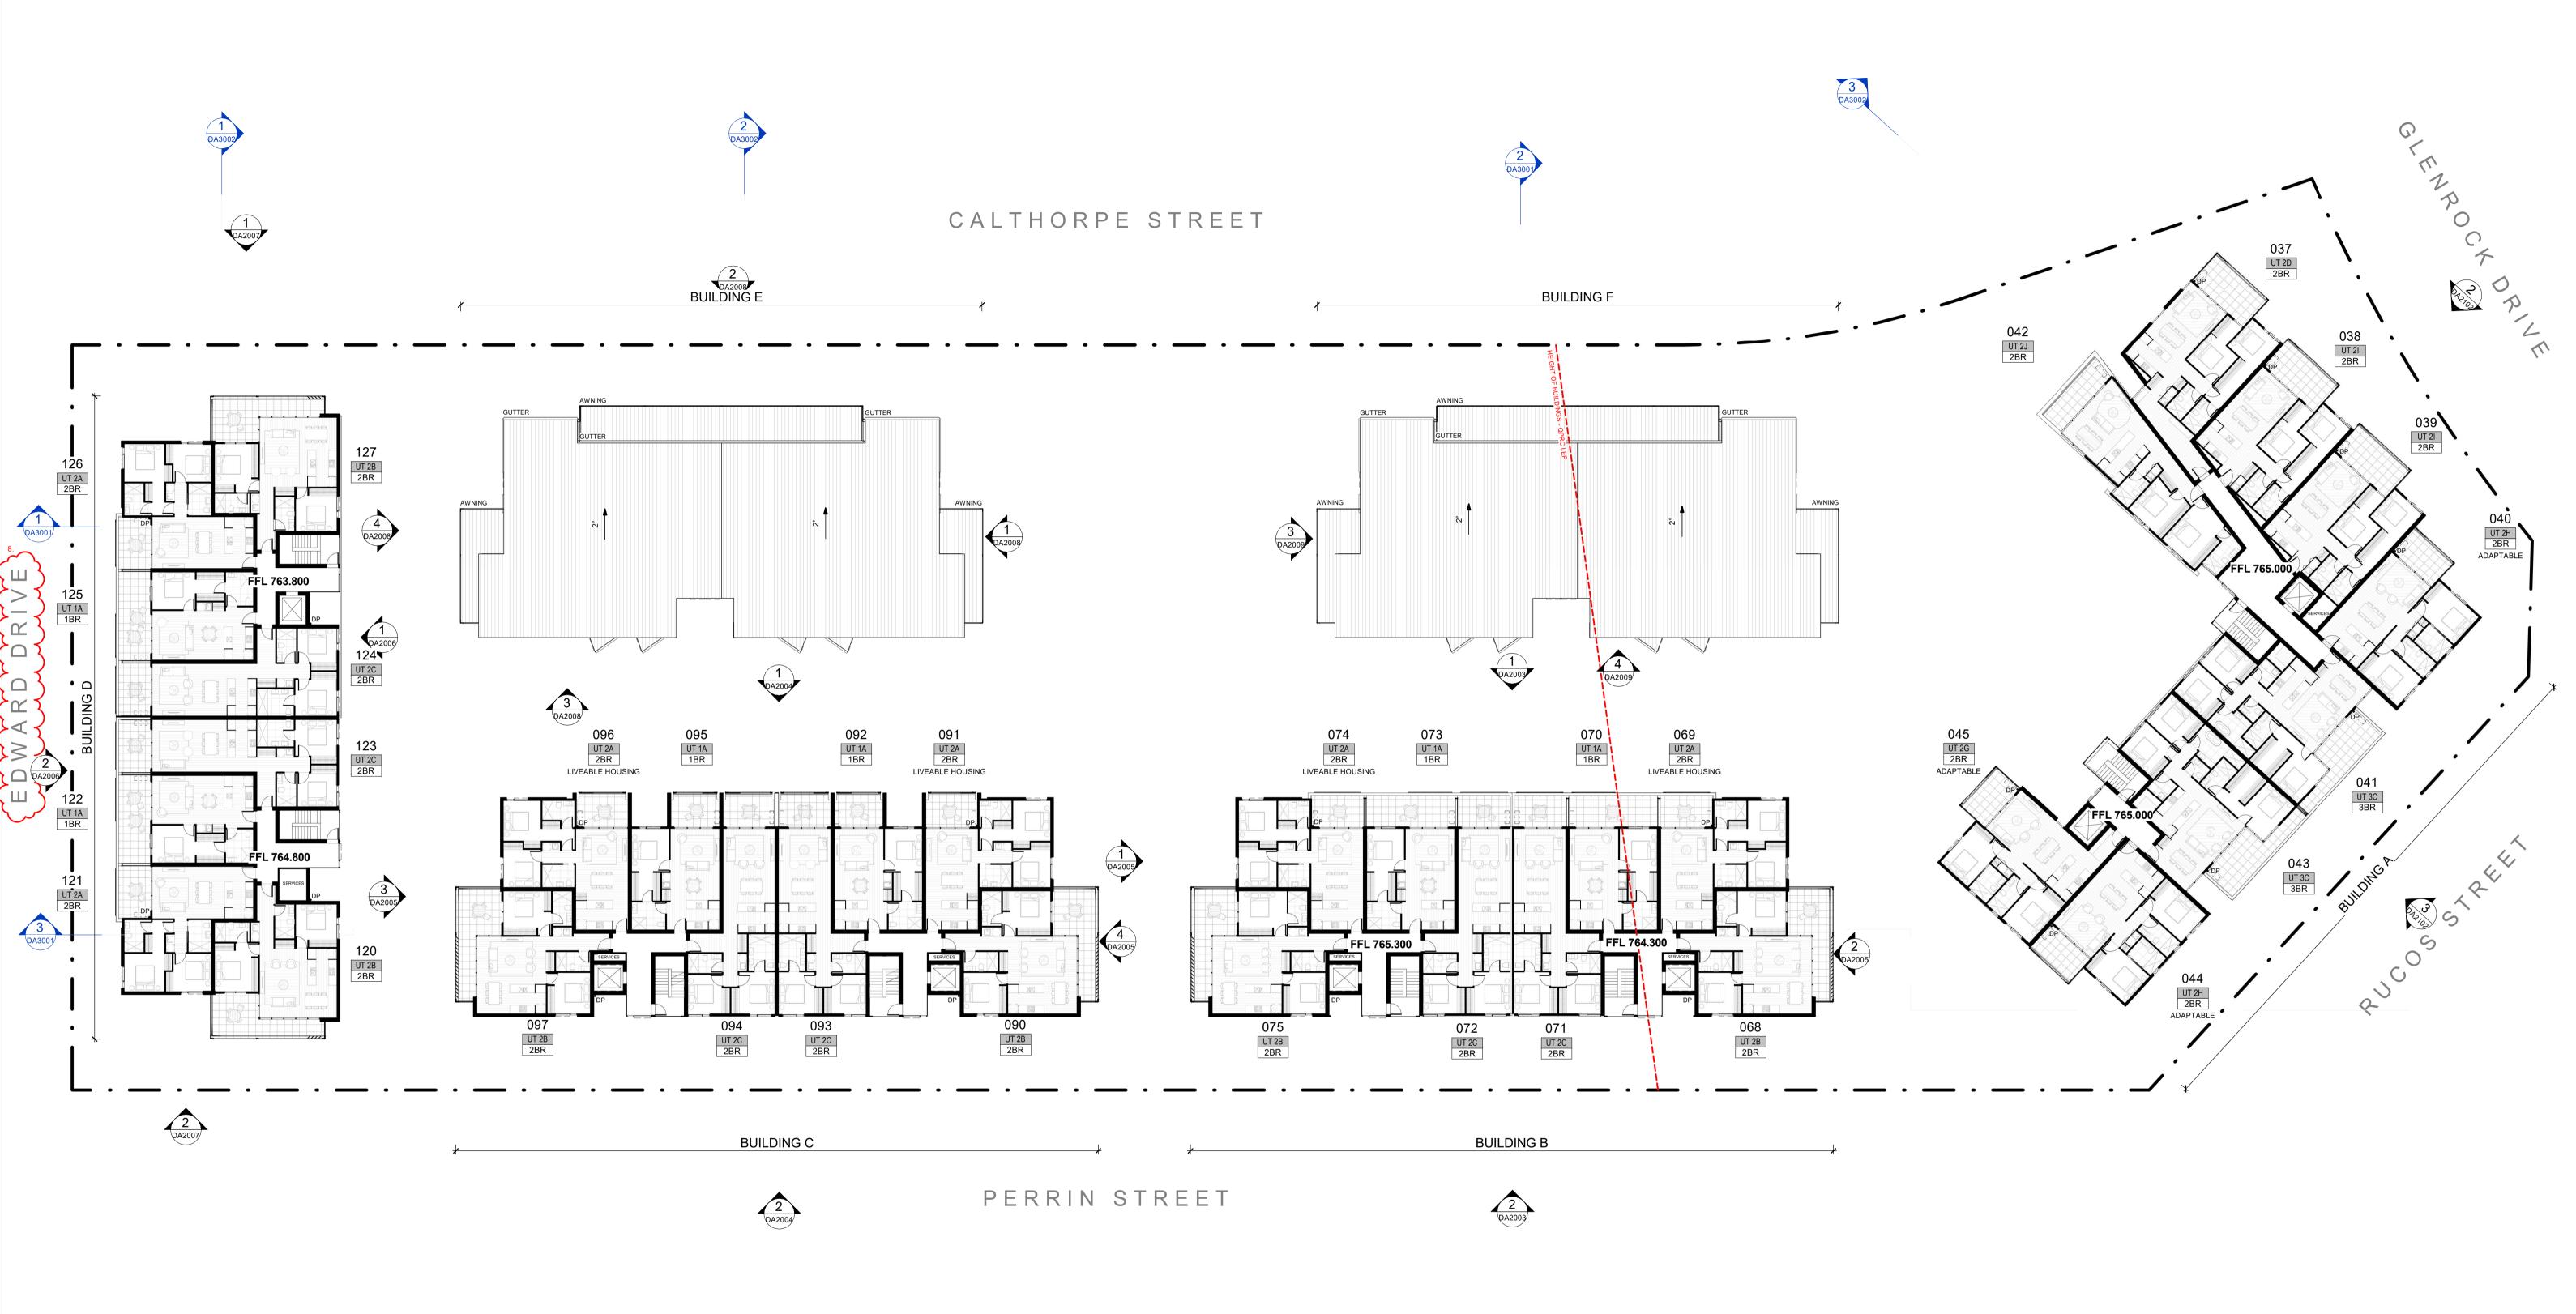


LOT 642 GOOGONG

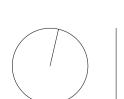

DRAWING NUMBER **DA1006** REVISION

8. PLAN INCLUSIONS AND ERRORS

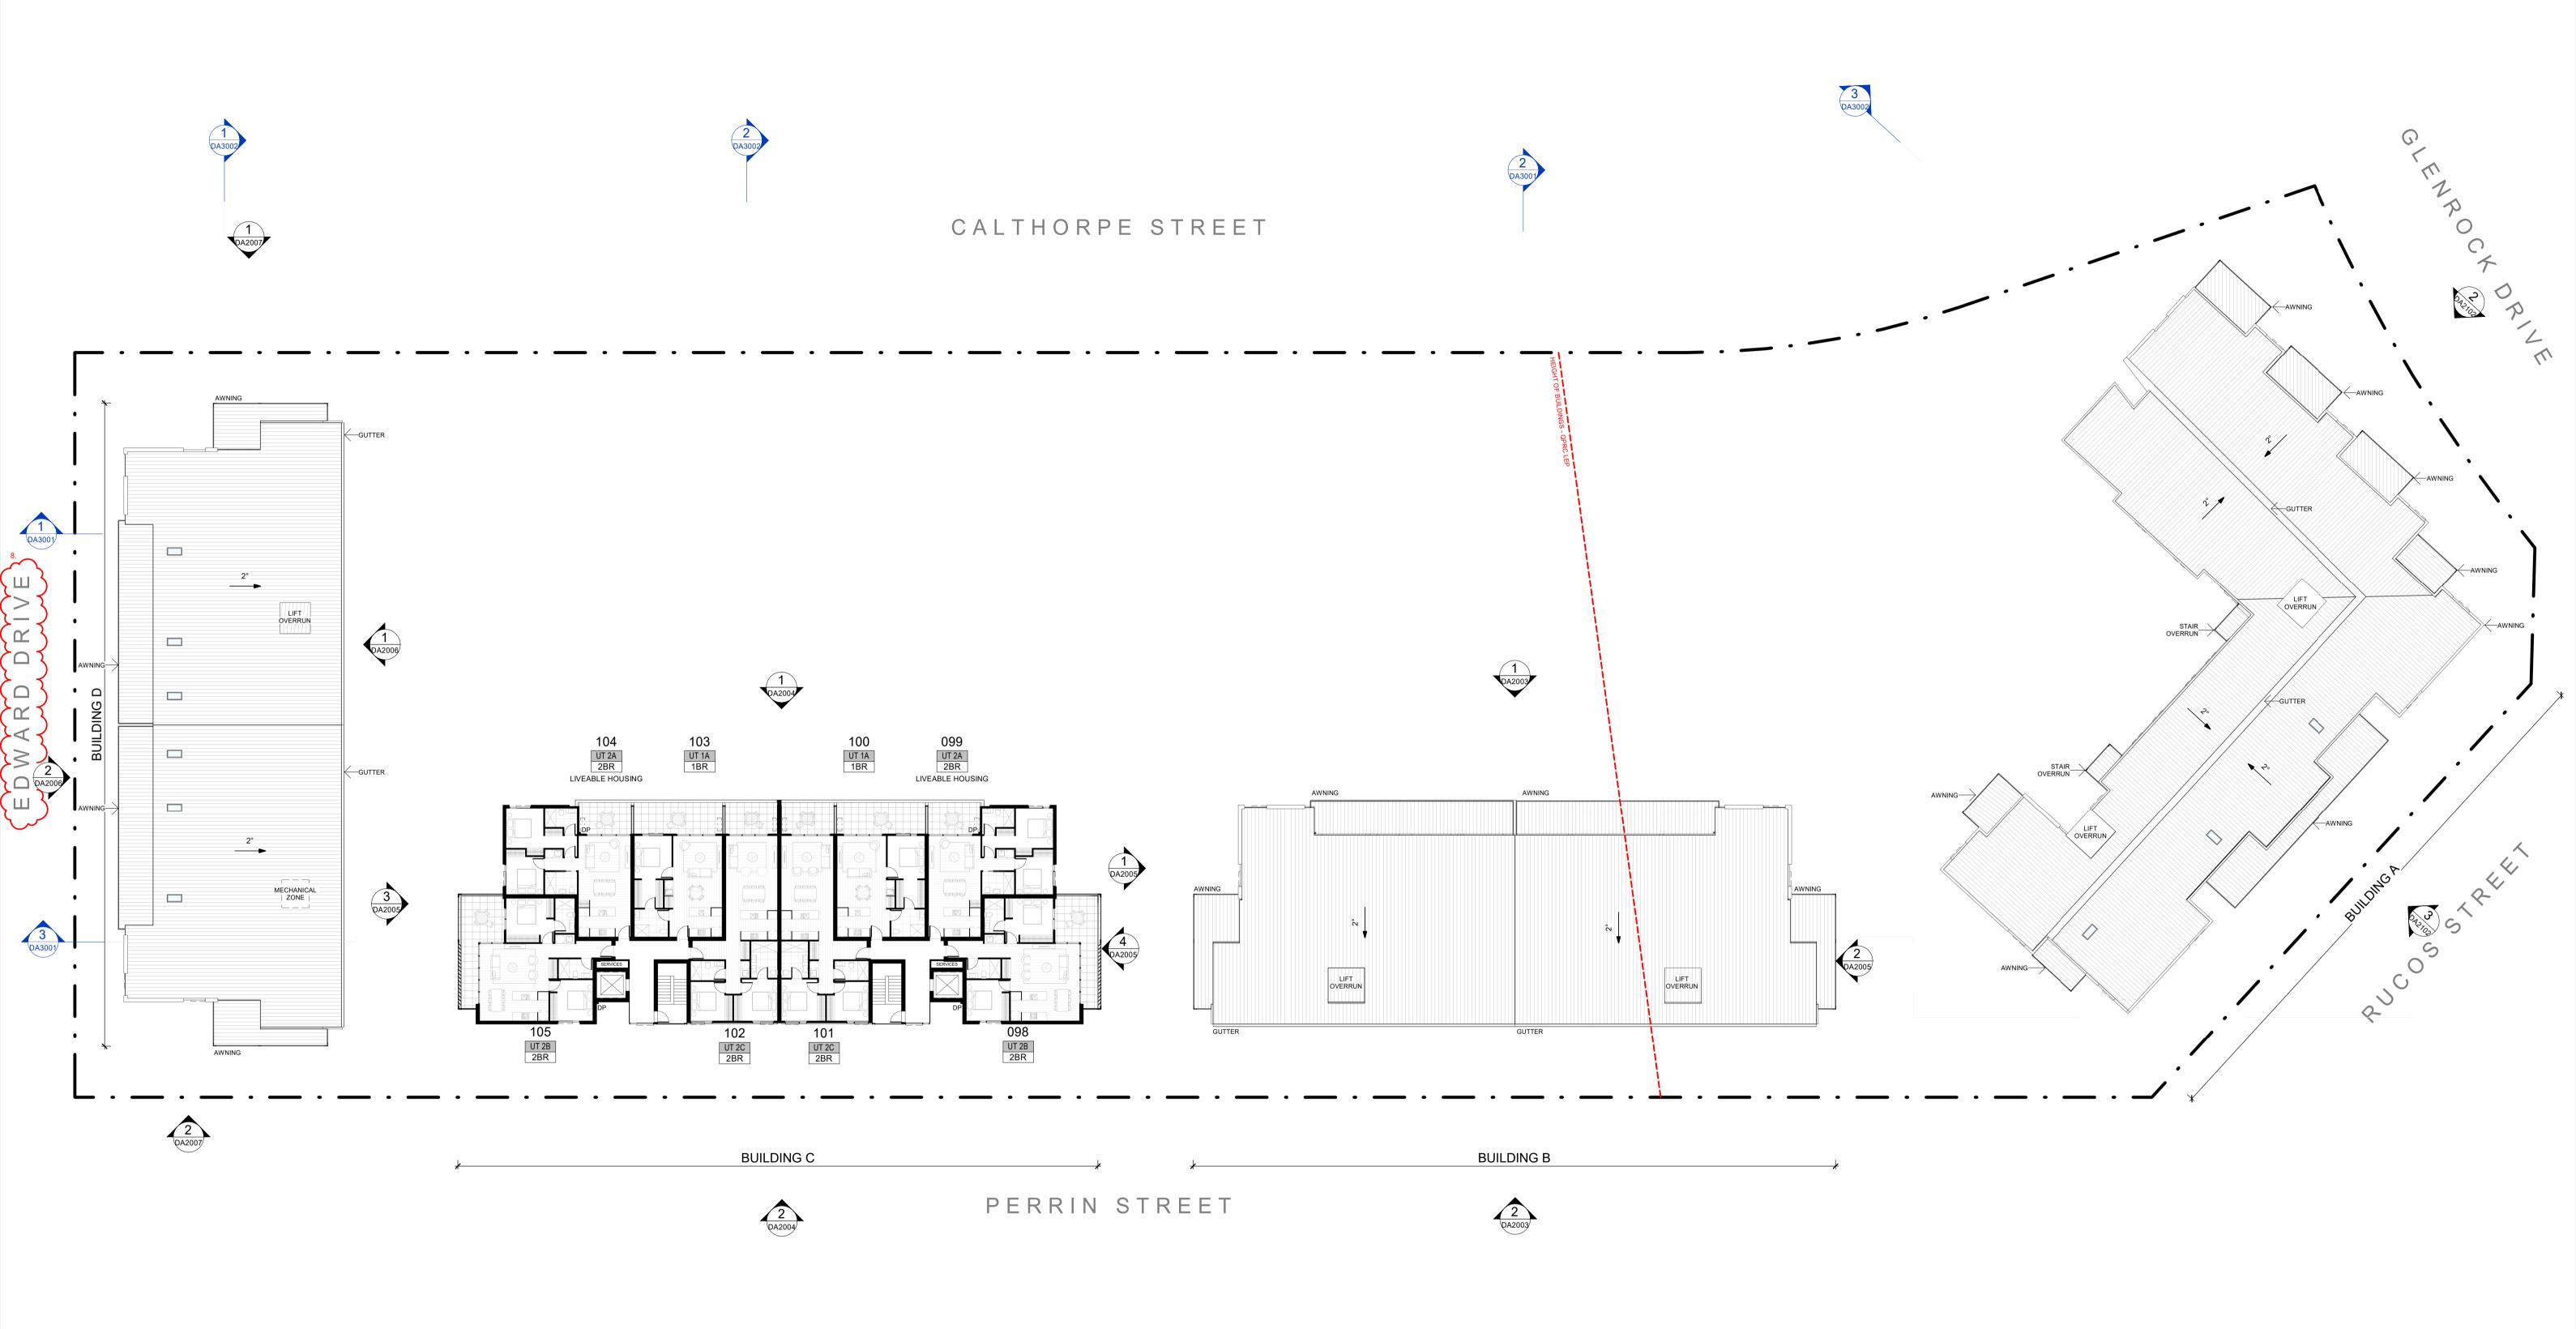


LOT 642 GOOGONG




DRAWING NUMBER **DA1007**

8. PLAN INCLUSIONS AND ERRORS

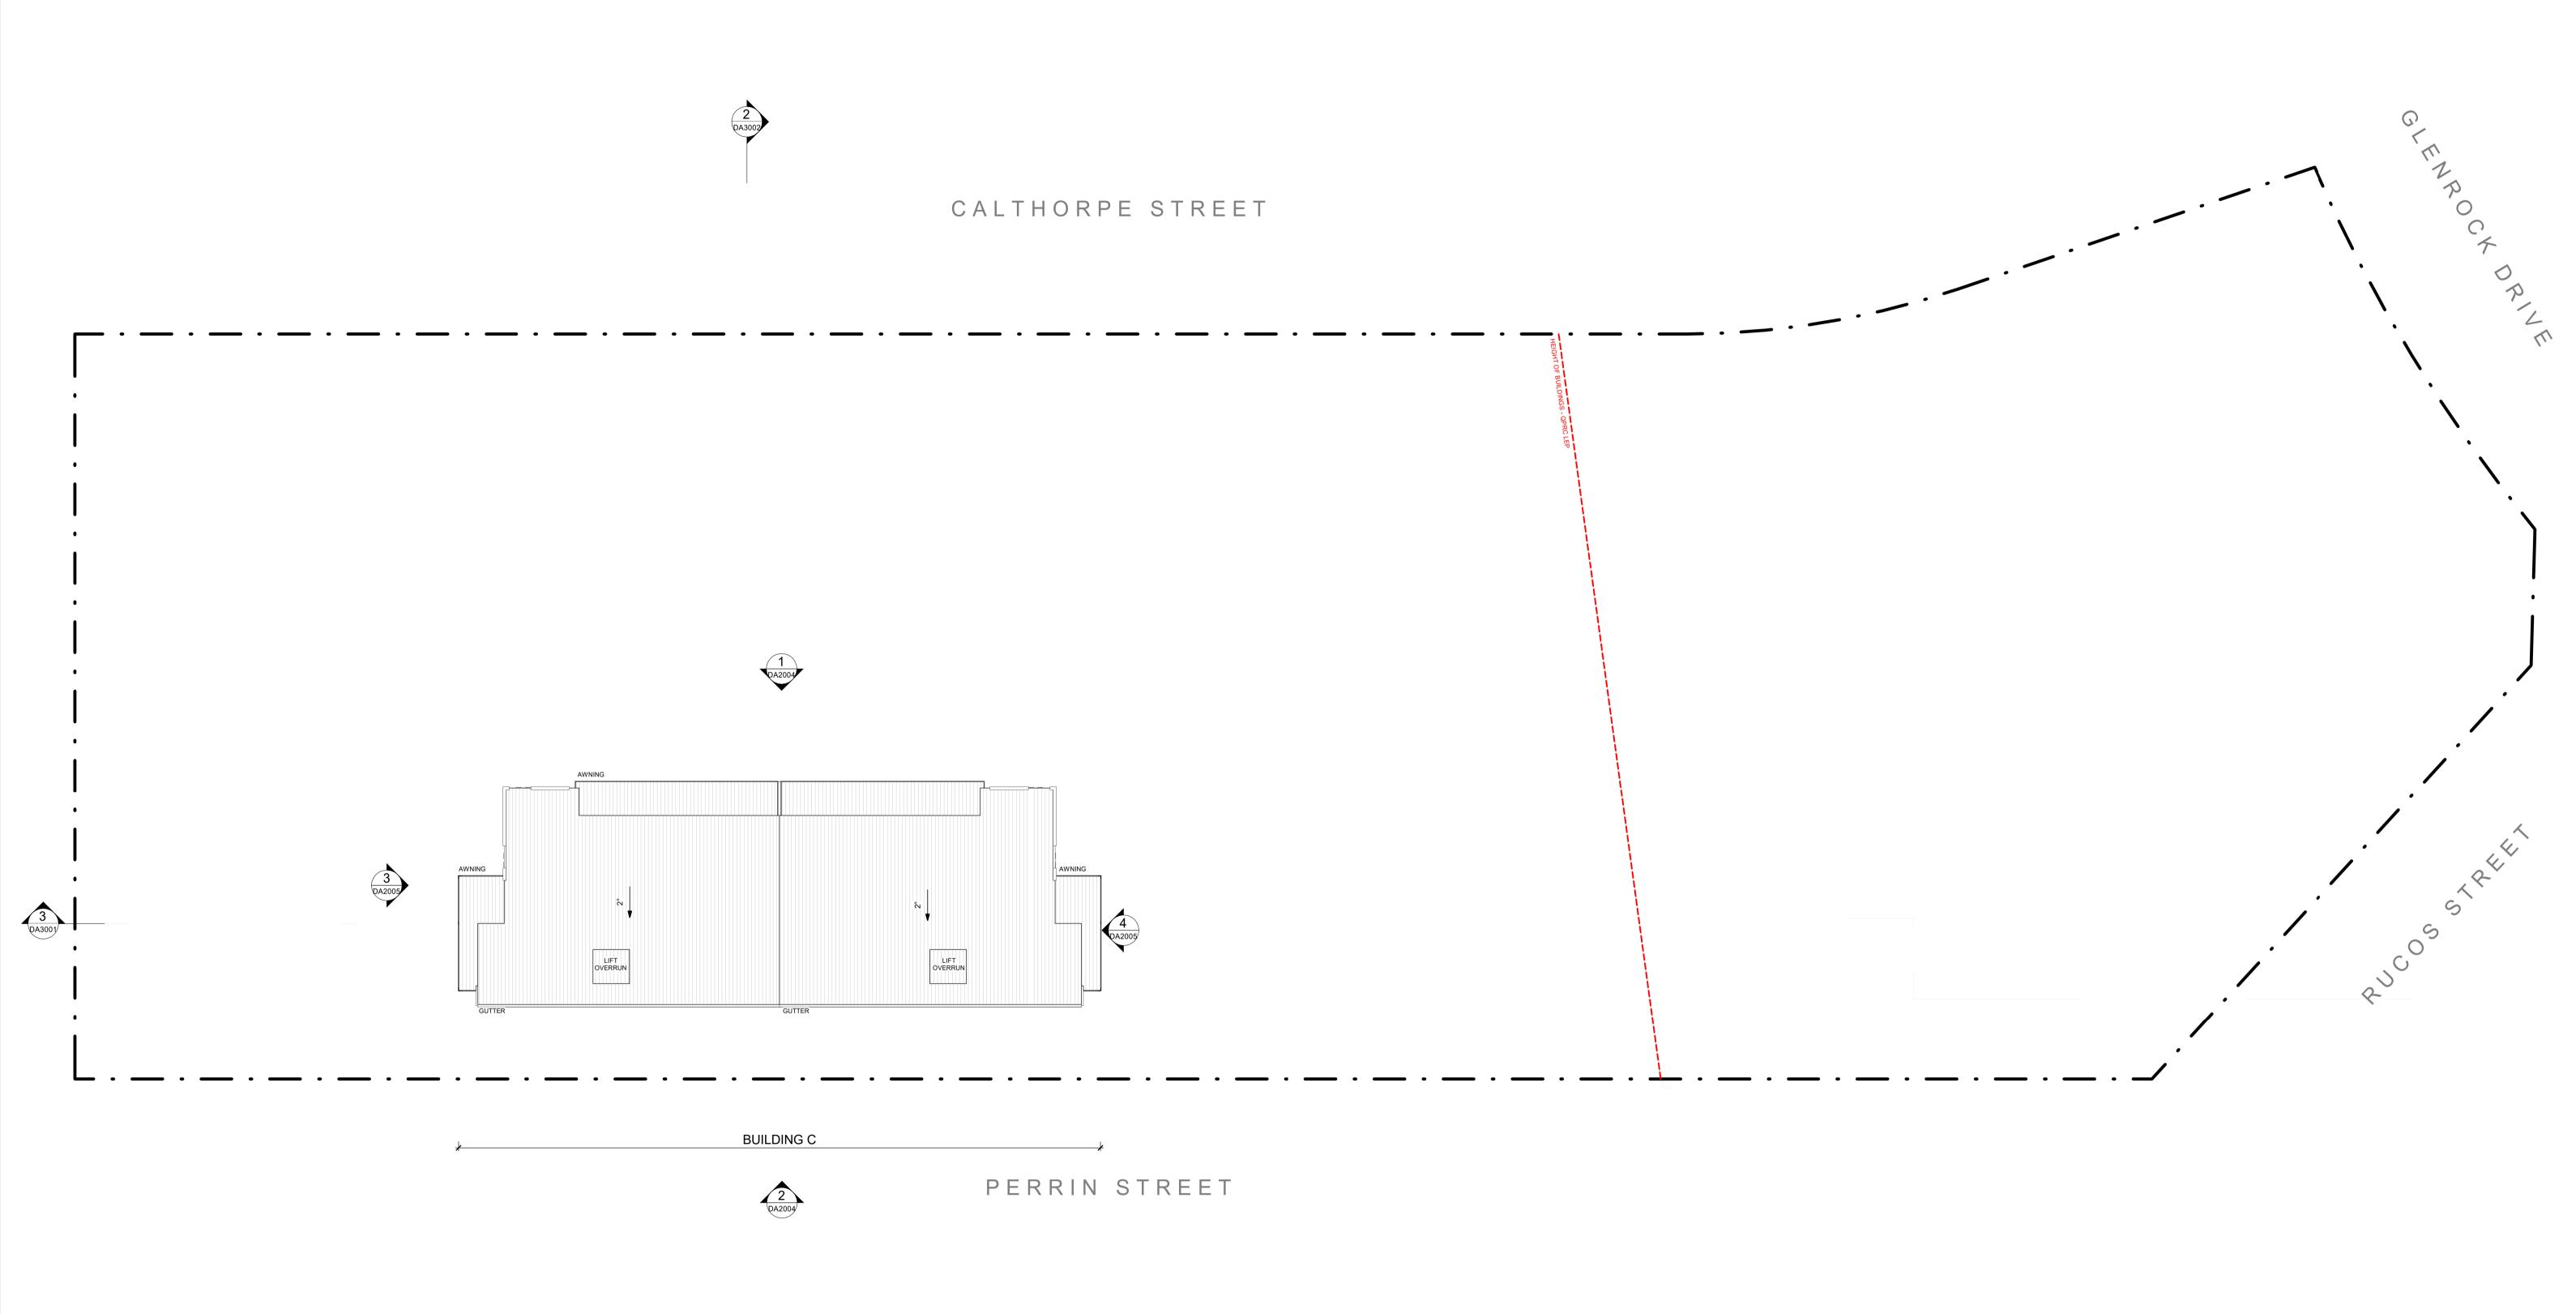

LOT 642 GOOGONG

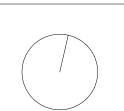

1:250 @ A1

DRAWING NUMBER **DA1008**

Canberra Studio: 10/285 Canberra Avenue Fyshwick ACT 2609. P: +61 2 6228 1200 Sydney Studio: 2/233-235 Bulwara Road Ultimo NSW 2007. P: +61 2 9061 4760 stewartarchitecture.com.au. Primary Nominee Marcus Graham ACT 1090. NSW 10921. ABN 89 765 826

2319 LOCATION

MATERIAL FINISHES SCHEDULE

BA1 BALUSTRADE

CW1 COURTYARD WALL

SP1 SPANDREL PANEL GREEN

ST1 STEELWORK

WF1 WINDOW FRAME

FE1 FENCE METAL PALISADE; DARK GREY FC1 FIBRE CEMENT CLADDING VERTICAL GROOVE; GREEN FC2 FIBRE CEMENT CLADDING SMOOTH FINISH; OFF WHITE FC3 FIBRE CEMENT CLADDING SMOOTH FINISH; GREEN METAL PALISADE; DARK GREY MR1 METAL ROOF METAL ROOF; GREEN FINISH PC1 CONCRETE WALL PRECAST CONCRETE TEXTURED FINISH; OFF WHITE PRECAST CONCRETE SMOOTH FINISH; OFF WHITE PC2 CONCRETE WALL SC1 SCREEN PERFORATED METAL; GREEN SC2 SCREEN ALUMINIUM LOUVRES; GREEN FIBRE CEMENT SOFFIT; PAINTED GREEN FINISH SO1 SOFFIT SO2 SOFFIT CONCRETE SOFFIT

FRAMELESS GLASS

SANDSTONE FACE FINISH

SPANDREL METAL PANEL; GREEN

WINDOW FRAME; DARK GREY

STEEL; GREEN FINISH

NORTH



EAST

LOT 642 GOOGONG

DRAWING NUMBER

DA2001

MATERIAL FINISHES SCHEDULE

WF1 WINDOW FRAME

FRAMELESS GLASS BA1 BALUSTRADE CW1 COURTYARD WALL SANDSTONE FACE FINISH FE1 FENCE METAL PALISADE; DARK GREY FC1 FIBRE CEMENT CLADDING VERTICAL GROOVE; GREEN FC2 FIBRE CEMENT CLADDING SMOOTH FINISH; OFF WHITE FC3 FIBRE CEMENT CLADDING SMOOTH FINISH; GREEN GA1 GATE METAL PALISADE; DARK GREY MR1 METAL ROOF METAL ROOF; GREEN FINISH PC1 CONCRETE WALL PRECAST CONCRETE TEXTURED FINISH; OFF WHITE PRECAST CONCRETE SMOOTH FINISH; OFF WHITE PC2 CONCRETE WALL SC1 SCREEN PERFORATED METAL; GREEN SC2 SCREEN ALUMINIUM LOUVRES; GREEN FIBRE CEMENT SOFFIT; PAINTED GREEN FINISH SO1 SOFFIT SO2 SOFFIT CONCRETE SOFFIT SP1 SPANDREL PANEL GREEN SPANDREL METAL PANEL; GREEN STEEL; GREEN FINISH ST1 STEELWORK

WINDOW FRAME; DARK GREY





StewartArchitecture

REFER TO MASTER PLAN FOR LEVELS

PORTION OF SECTION DRAWN THROUGH CALTHORPE STREET SIDE

LOT 642 GOOGONG

10/11/2023

27/11/2023

REFER TO MASTER PLAN FOR LEVELS

PORTION OF SECTION DRAWN THROUGH DRIVEWAY LEVELS FOR CLARITY

1:100 @ A1

MATERIAL FINISHES SCHEDULE — **ROOF** FFL 768.400 BA1 BALUSTRADE FRAMELESS GLASS SANDSTONE FACE FINISH CW1 COURTYARD WALL FFL 767.400 METAL PALISADE; DARK GREY FC1 FIBRE CEMENT CLADDING VERTICAL GROOVE; GREEN SMOOTH FINISH; OFF WHITE FC2 FIBRE CEMENT CLADDING FC3 FIBRE CEMENT CLADDING SMOOTH FINISH; GREEN METAL PALISADE; DARK GREY **LEVEL 3** FFL 764.300 METAL ROOF: GREEN FINISH MR1 METAL ROOF PC1 CONCRETE WALL PRECAST CONCRETE TEXTURED FINISH; OFF WHITE PRECAST CONCRETE SMOOTH FINISH; OFF WHITE PC2 CONCRETE WALL PERFORATED METAL; GREEN SC1 SCREEN ALUMINIUM LOUVRES; GREEN SC2 SCREEN FIBRE CEMENT SOFFIT; PAINTED GREEN FINISH CONCRETE SOFFIT SO2 SOFFIT SP1 SPANDREL PANEL GREEN SPANDREL METAL PANEL; GREEN STEEL; GREEN FINISH WF1 WINDOW FRAME WINDOW FRAME; DARK GREY **LEVEL 1** - FFL 758.100 **GROUND** - FFL 755.000 ·-- **BASEMENT**

NORTH



10/11/2023

27/11/2023

SOUTH

DRAWING NUMBER

MATERIAL FINISHES SCHEDULE BA1 BALUSTRADE FRAMELESS GLASS CW1 COURTYARD WALL SANDSTONE FACE FINISH FFL 770.400 METAL PALISADE; DARK GREY FC1 FIBRE CEMENT CLADDING VERTICAL GROOVE; GREEN SMOOTH FINISH; OFF WHITE FC2 FIBRE CEMENT CLADDING FC3 FIBRE CEMENT CLADDING SMOOTH FINISH; GREEN METAL PALISADE; DARK GREY **LEVEL 3** FFL 767.300 METAL ROOF: GREEN FINISH MR1 METAL ROOF PC1 CONCRETE WALL PRECAST CONCRETE TEXTURED FINISH; OFF WHITE PRECAST CONCRETE SMOOTH FINISH; OFF WHITE PC2 CONCRETE WALL PERFORATED METAL; GREEN SC1 SCREEN ALUMINIUM LOUVRES; GREEN SC2 SCREEN FIBRE CEMENT SOFFIT; PAINTED GREEN FINISH SO2 SOFFIT CONCRETE SOFFIT SP1 SPANDREL PANEL GREEN SPANDREL METAL PANEL; GREEN STEEL; GREEN FINISH ST1 STEELWORK

.______

BASEMENT

NORTH

LEVEL 1 FFL 761.100

GROUND FFL 758.000



10/11/2023

27/11/2023

SOUTH

1:100 @ A1

DRAWING NUMBER

WF1 WINDOW FRAME

WINDOW FRAME; DARK GREY

MATERIAL FINISHES SCHEDULE BA1 BALUSTRADE FRAMELESS GLASS CW1 COURTYARD WALL SANDSTONE FACE FINISH METAL PALISADE; DARK GREY FFL 768.400 FC1 FIBRE CEMENT CLADDING VERTICAL GROOVE; GREEN FC2 FIBRE CEMENT CLADDING SMOOTH FINISH; OFF WHITE FC3 FIBRE CEMENT CLADDING SMOOTH FINISH; GREEN METAL PALISADE; DARK GREY **LEVEL 3** FFL 765.300 MR1 METAL ROOF METAL ROOF; GREEN FINISH PRECAST CONCRETE TEXTURED FINISH; OFF WHITE PC1 CONCRETE WALL PRECAST CONCRETE SMOOTH FINISH; OFF WHITE PC2 CONCRETE WALL SC1 SCREEN PERFORATED METAL; GREEN SC2 SCREEN ALUMINIUM LOUVRES; GREEN FIBRE CEMENT SOFFIT; PAINTED GREEN FINISH SO1 SOFFIT **LEVEL 2** FFL 761.200 LEVEL 2 SO2 SOFFIT CONCRETE SOFFIT SP1 SPANDREL PANEL GREEN SPANDREL METAL PANEL; GREEN ST1 STEELWORK STEEL; GREEN FINISH WF1 WINDOW FRAME WINDOW FRAME; DARK GREY **LEVEL 1** FFL 758.100 FFL 755.000 BASEMENT BASEMENT L-----**BUILDING C - EAST BUILDING B - EAST** LEVEL 3 FFL 768.300 FC2----**LEVEL 2** FFL 762.200 FFL 765.200 **LEVEL 1** FFL 759.100 LEVEL 1 GROUND FFL 759.000 BASEMENT BASEMENT ______ BASEMENT BASEMENT L------

BUILDING B - WEST

10/11/2023

27/11/2023

BUILDING C - WEST

LOT 642 GOOGONG

1:100 @ A1

MATERIAL FINISHES SCHEDULE

FRAMELESS GLASS

BA1 BALUSTRADE

CW1 COURTYARD WALL SANDSTONE FACE FINISH METAL PALISADE; DARK GREY FE1 FENCE FC1 FIBRE CEMENT CLADDING VERTICAL GROOVE; GREEN FC2 FIBRE CEMENT CLADDING SMOOTH FINISH; OFF WHITE FC3 FIBRE CEMENT CLADDING SMOOTH FINISH; GREEN GA1 GATE METAL PALISADE; DARK GREY METAL ROOF; GREEN FINISH MR1 METAL ROOF PRECAST CONCRETE TEXTURED FINISH; OFF WHITE PC1 CONCRETE WALL PRECAST CONCRETE SMOOTH FINISH; OFF WHITE PC2 CONCRETE WALL SC1 SCREEN PERFORATED METAL; GREEN FFL 767.900 ALUMINIUM LOUVRES; GREEN SC2 SCREEN FIBRE CEMENT SOFFIT; PAINTED GREEN FINISH SO1 SOFFIT SO2 SOFFIT CONCRETE SOFFIT SPANDREL METAL PANEL; GREEN SP1 SPANDREL PANEL GREEN **LEVEL 2** FFL 764.800 STEEL; GREEN FINISH ST1 STEELWORK WF1 WINDOW FRAME WINDOW FRAME; DARK GREY **EAST** ROOF FFL 766.900 **LEVEL 2** _ FFL 763.800 **LEVEL 1** _ FFL 760.700 **GROUND** __ FFL 757.600 -----WEST 2. BASEMENT 1 EXTENDED FOR ADDITIONAL PARKING. BASEMENT PARKING ADJUSTMENTS MADE.

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LOT 642 GOOGONG

1:100 @ A1

MATERIAL FINISHES SCHEDULE

BA1 BALUSTRADE FRAMELESS GLASS CW1 COURTYARD WALL SANDSTONE FACE FINISH METAL PALISADE; DARK GREY FE1 FENCE FC1 FIBRE CEMENT CLADDING VERTICAL GROOVE; GREEN FC2 FIBRE CEMENT CLADDING SMOOTH FINISH; OFF WHITE FC3 FIBRE CEMENT CLADDING SMOOTH FINISH; GREEN GA1 GATE METAL PALISADE; DARK GREY

METAL ROOF; GREEN FINISH MR1 METAL ROOF

PRECAST CONCRETE TEXTURED FINISH; OFF WHITE PC1 CONCRETE WALL PRECAST CONCRETE SMOOTH FINISH; OFF WHITE PC2 CONCRETE WALL

SC1 SCREEN PERFORATED METAL; GREEN ALUMINIUM LOUVRES; GREEN SC2 SCREEN

SO1 SOFFIT FIBRE CEMENT SOFFIT; PAINTED GREEN FINISH SO2 SOFFIT

SP1 SPANDREL PANEL GREEN SPANDREL METAL PANEL; GREEN ST1 STEELWORK STEEL; GREEN FINISH WF1 WINDOW FRAME WINDOW FRAME; DARK GREY





2. BASEMENT 1 EXTENDED FOR ADDITIONAL PARKING. BASEMENT PARKING ADJUSTMENTS MADE.

LOT 642 GOOGONG

DRAWING NUMBER







BASEMENT

WEST

EAST

LEVEL 2 FFL 762.200

LEVEL 1 FFL 759.100

SOUTH

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REV DESCRIPTION

A DRAFT DEVELOPMENT APPLICATION

B DEVELOPMENT APPLICATION

DATE 10/11/2023 27/11/2023 PROJECT NAME
GOOGONG
PROJECT NUMBER
2319
LOCATION
LOT 642 GOOGONG
CLIENT
BASE DEVELOPMENTS

DRAWING TITLE

ELEVATIONS - BUILDING E

SCALE 1:100 @ A1

BASEMENT

DA2008

REVISION

CENTRAL LANDSCAPE





NORTH






StewartArchitecture

10/11/2023


27/11/2023

SOUTH

EAST

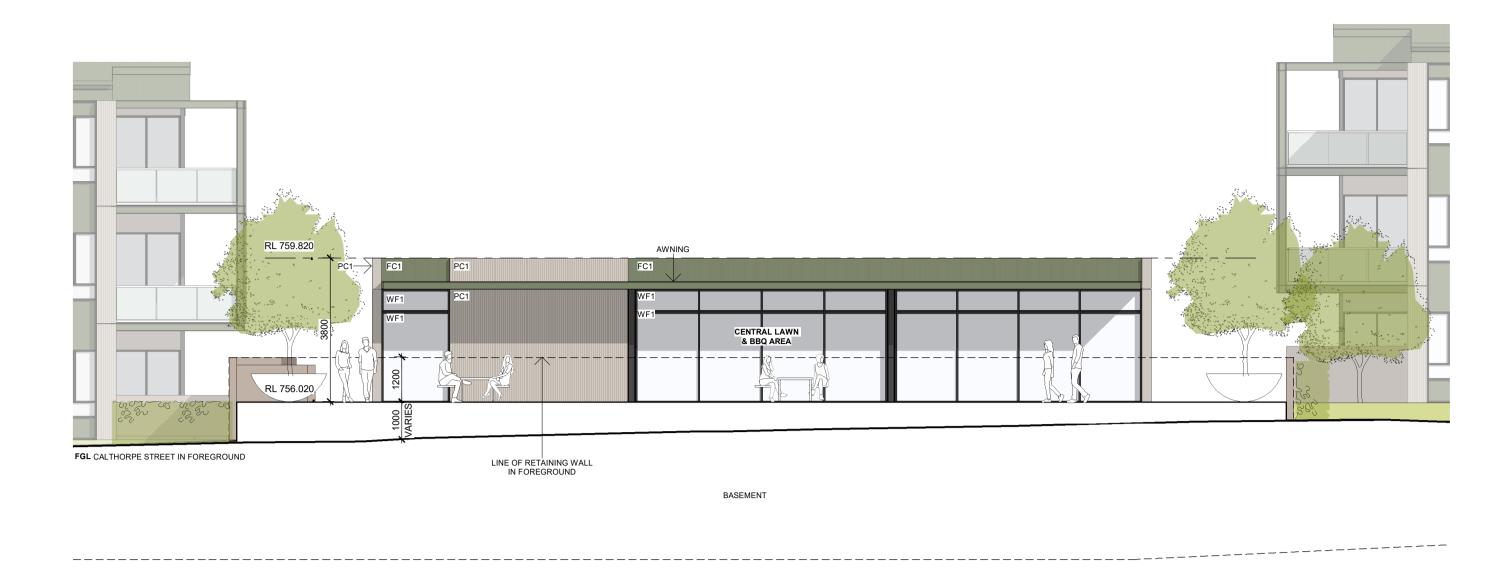

COMMUNAL LOUNGE - NORTH

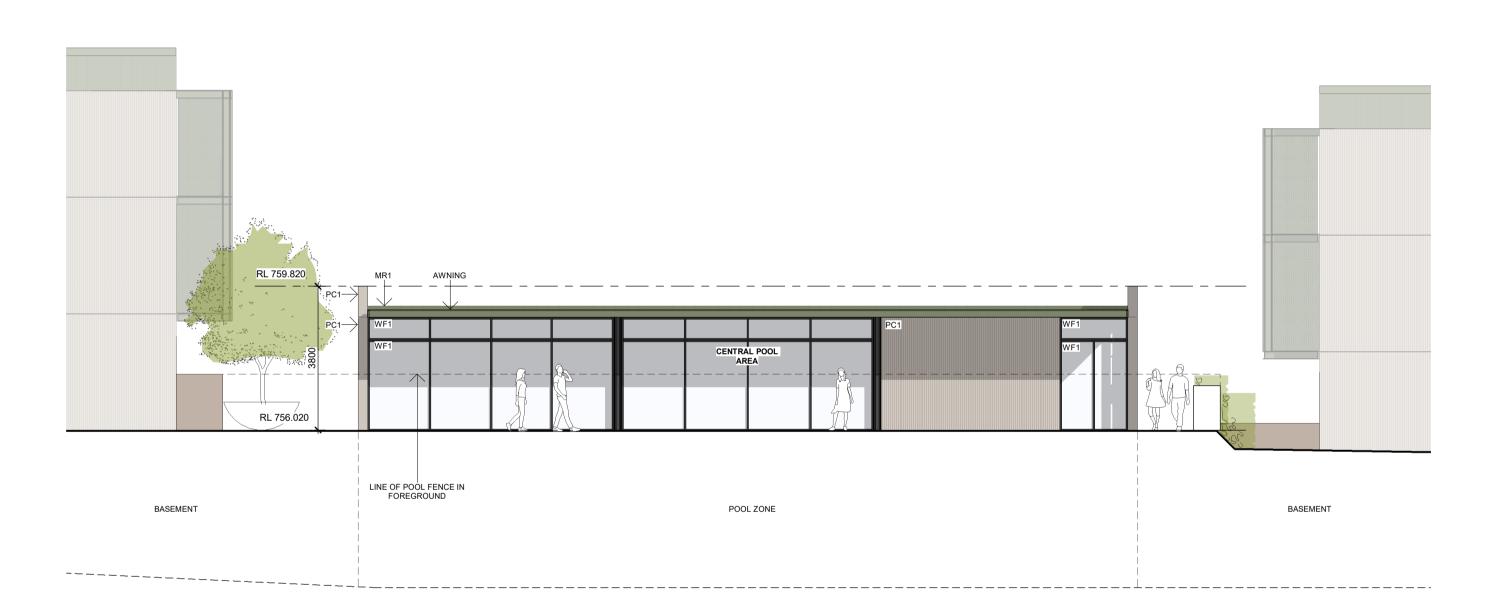


COMMUNAL LOUNGE - SOUTH


MATERIAL FINISHES SCHEDULE

BA1 BALUSTRADE FRAMELESS GLASS CW1 COURTYARD WALL SANDSTONE FACE FINISH FE1 FENCE METAL PALISADE; DARK GREY FC1 FIBRE CEMENT CLADDING VERTICAL GROOVE; GREEN FC2 FIBRE CEMENT CLADDING SMOOTH FINISH; OFF WHITE SMOOTH FINISH; GREEN FC3 FIBRE CEMENT CLADDING GA1 GATE METAL PALISADE; DARK GREY MR1 METAL ROOF METAL ROOF; GREEN FINISH PC1 CONCRETE WALL PRECAST CONCRETE TEXTURED FINISH; OFF WHITE PC2 CONCRETE WALL PRECAST CONCRETE SMOOTH FINISH; OFF WHITE SC1 SCREEN PERFORATED METAL; GREEN ALUMINIUM LOUVRES; GREEN SC2 SCREEN SO1 SOFFIT FIBRE CEMENT SOFFIT; PAINTED GREEN FINISH

SO2 SOFFIT CONCRETE SOFFIT SP1 SPANDREL PANEL GREEN SPANDREL METAL PANEL; GREEN STEEL; GREEN FINISH ST1 STEELWORK WF1 WINDOW FRAME WINDOW FRAME; DARK GREY

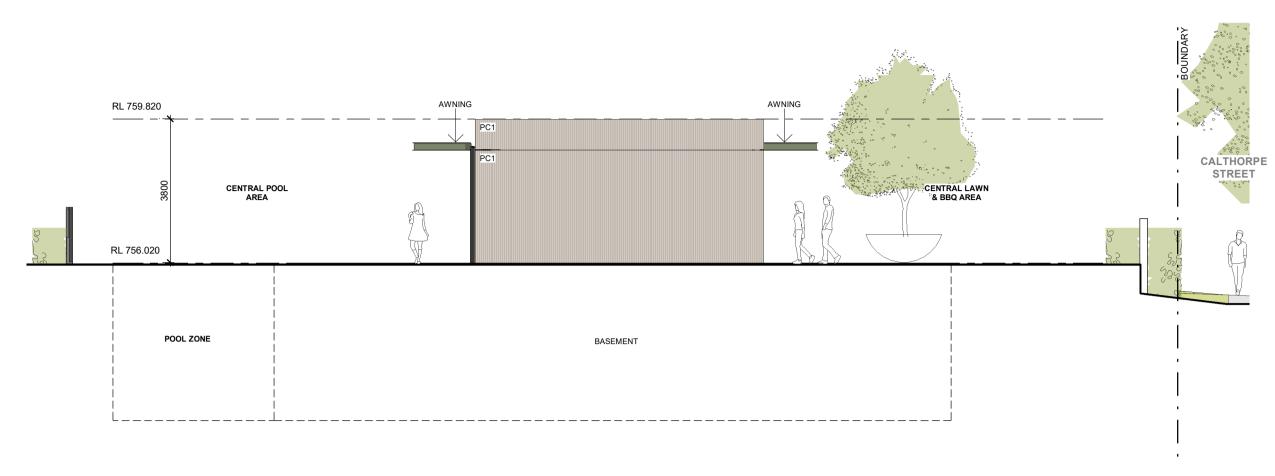


COMMUNAL LOUNGE - EAST

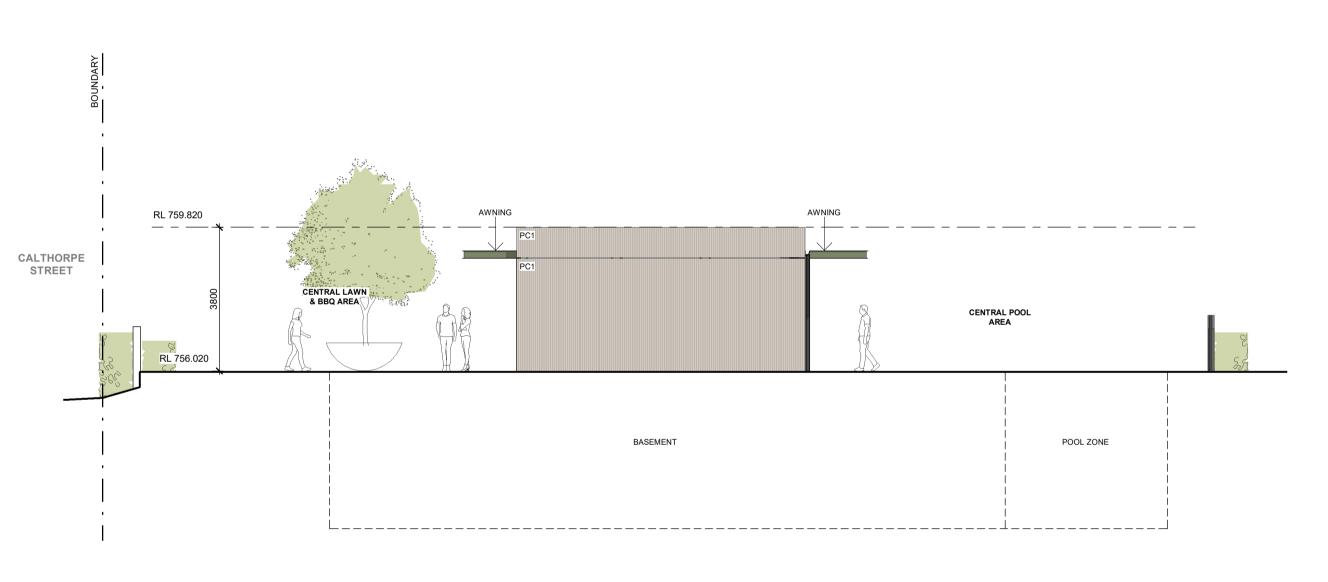

COMMUNAL LOUNGE - WEST

REV DESCRIPTION

LOT 642 GOOGONG

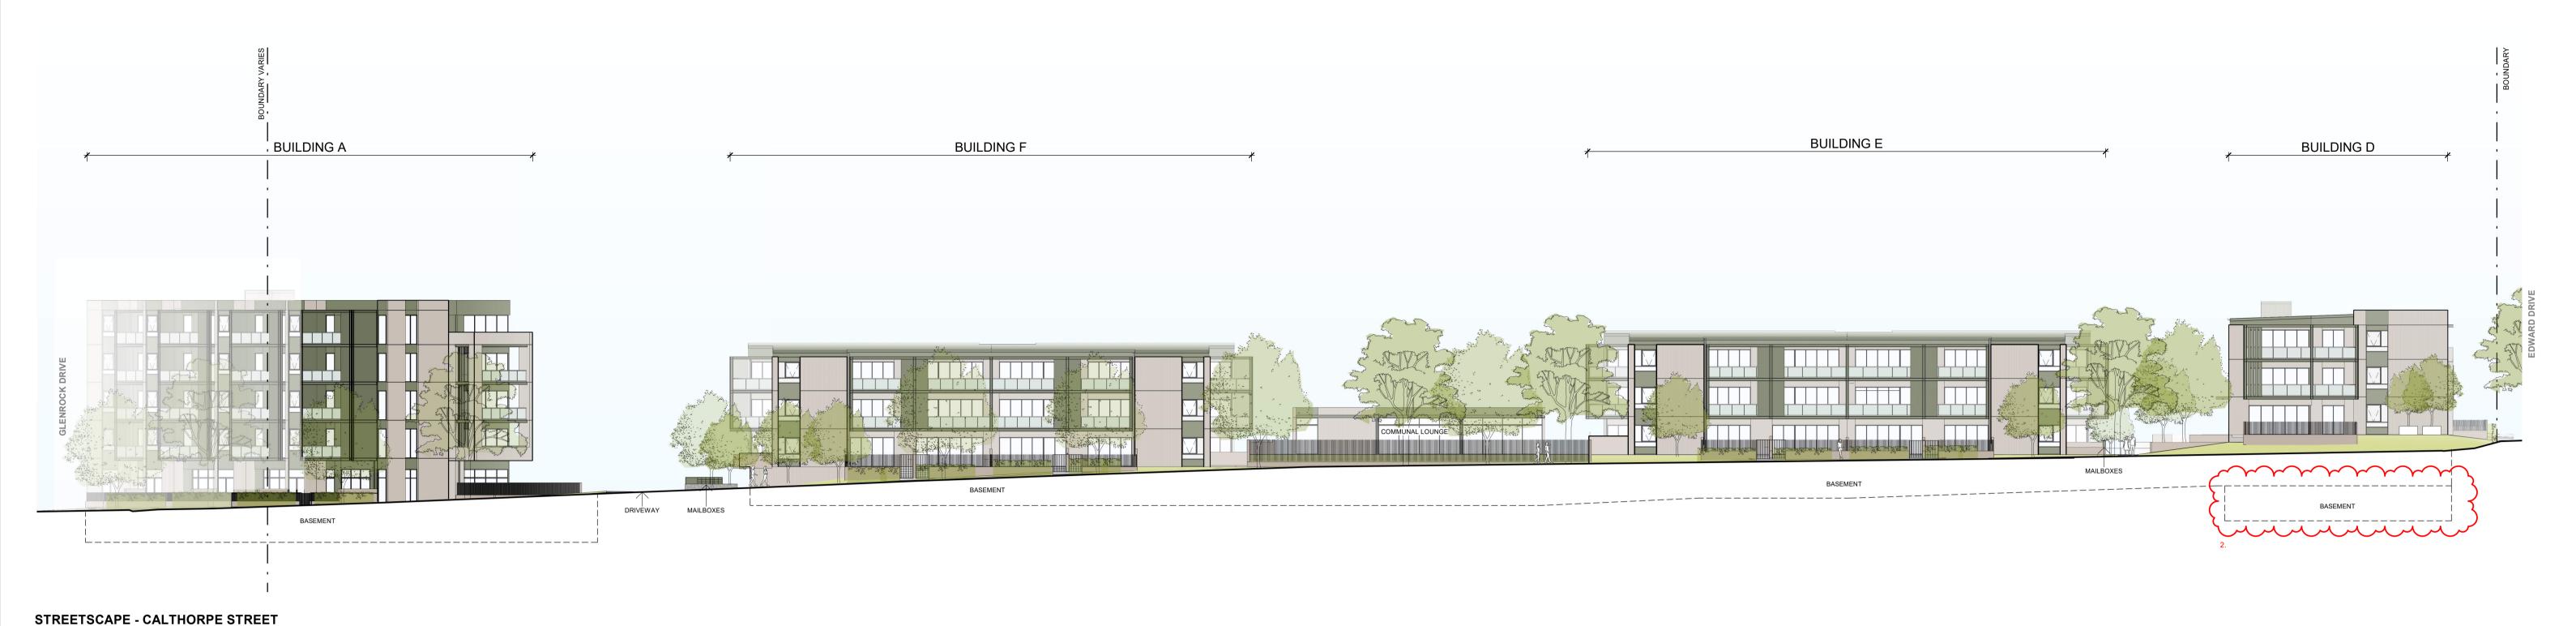



STREETSCAPE - PERRIN STREET

2. BASEMENT 1 EXTENDED FOR ADDITIONAL PARKING. BASEMENT PARKING ADJUSTMENTS MADE.

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REV DESCRIPTION

A DRAFT DEVELOPMENT APPLICATION

B DEVELOPMENT APPLICATION

C ISSUE FOR DA RFI

DATE 10/11/2023 27/11/2023 29/07/2024 PROJECT NAME
GOOGONG
PROJECT NUMBER
2319
LOCATION


LOT 642 GOOGONG

CLIENT
BASE DEVELOPMENTS

DRAWING TITLE
ELEVATIONS - COMPOSITE
STREETSCAPE

SCALE 1:250 @ A1 DA2101

REVISION

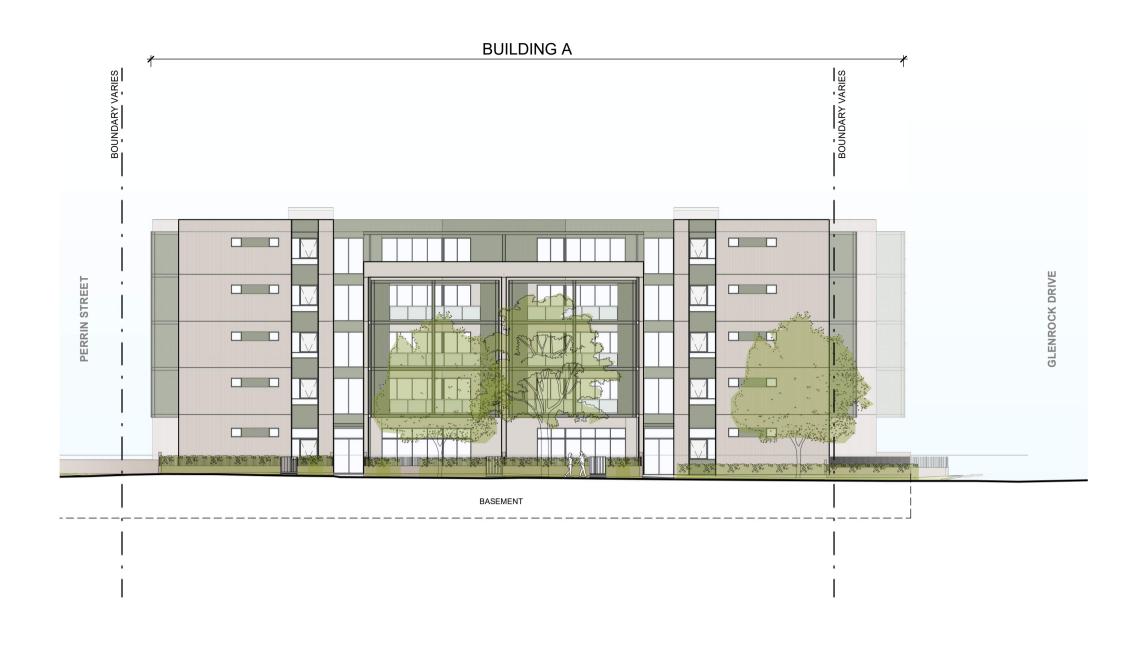

STREETSCAPE - RUCOS STREET






STREETSCAPE - GLENROCK DRIVE

LOT 642 GOOGONG



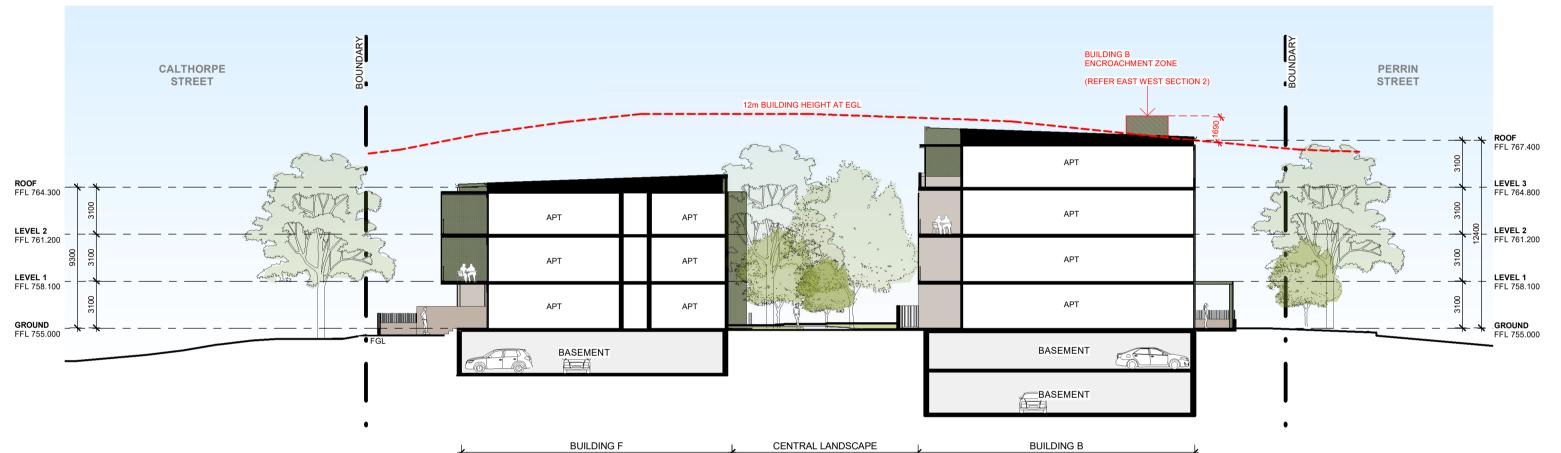

OVERALL SECTION - NORTH SOUTH



OVERALL SECTION - EAST WEST 2

2. BASEMENT 1 EXTENDED FOR ADDITIONAL PARKING. BASEMENT PARKING ADJUSTMENTS MADE.

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DRAFT DEVELOPMENT APPLICATION DEVELOPMENT APPLICATION ISSUE FOR DA RFI ISSUE FOR DA RFI

10/11/2023 27/11/2023 02/07/2024 29/07/2024


PROJECT NAME GOOGONG PROJECT NUMBER **BASE DEVELOPMENTS** 2319 LOCATION

LOT 642 GOOGONG

DRAWING TITLE **SECTIONS - OVERALL**

1:250 @ A1


DRAWING NUMBER **DA3001**

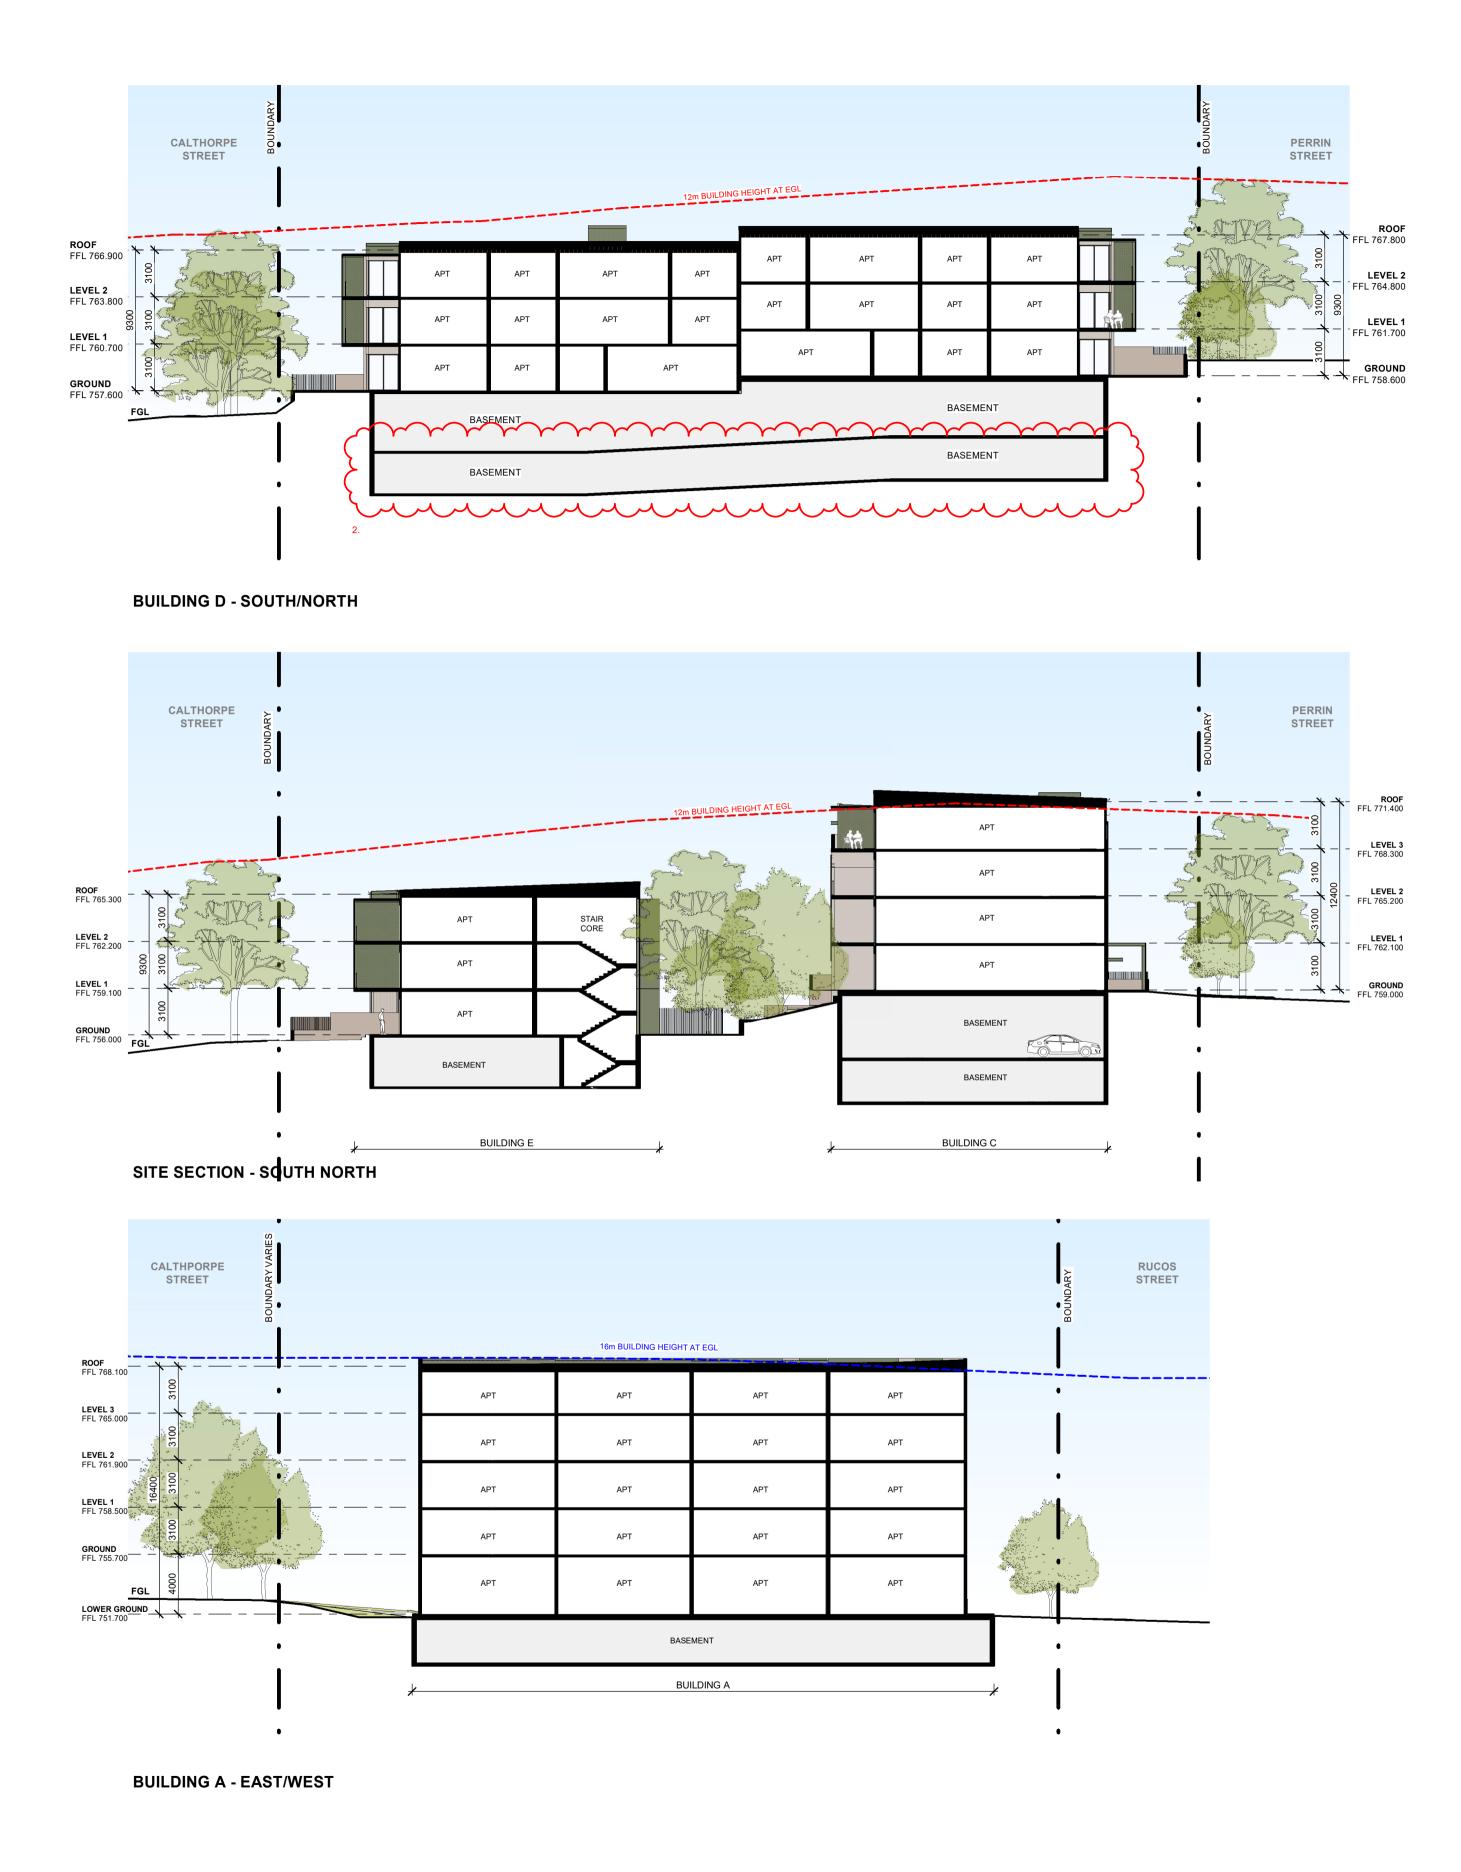

2. BASEMENT 1 EXTENDED FOR ADDITIONAL PARKING. BASEMENT PARKING ADJUSTMENTS MADE.

LOT 642 GOOGONG

DRAWING NUMBER

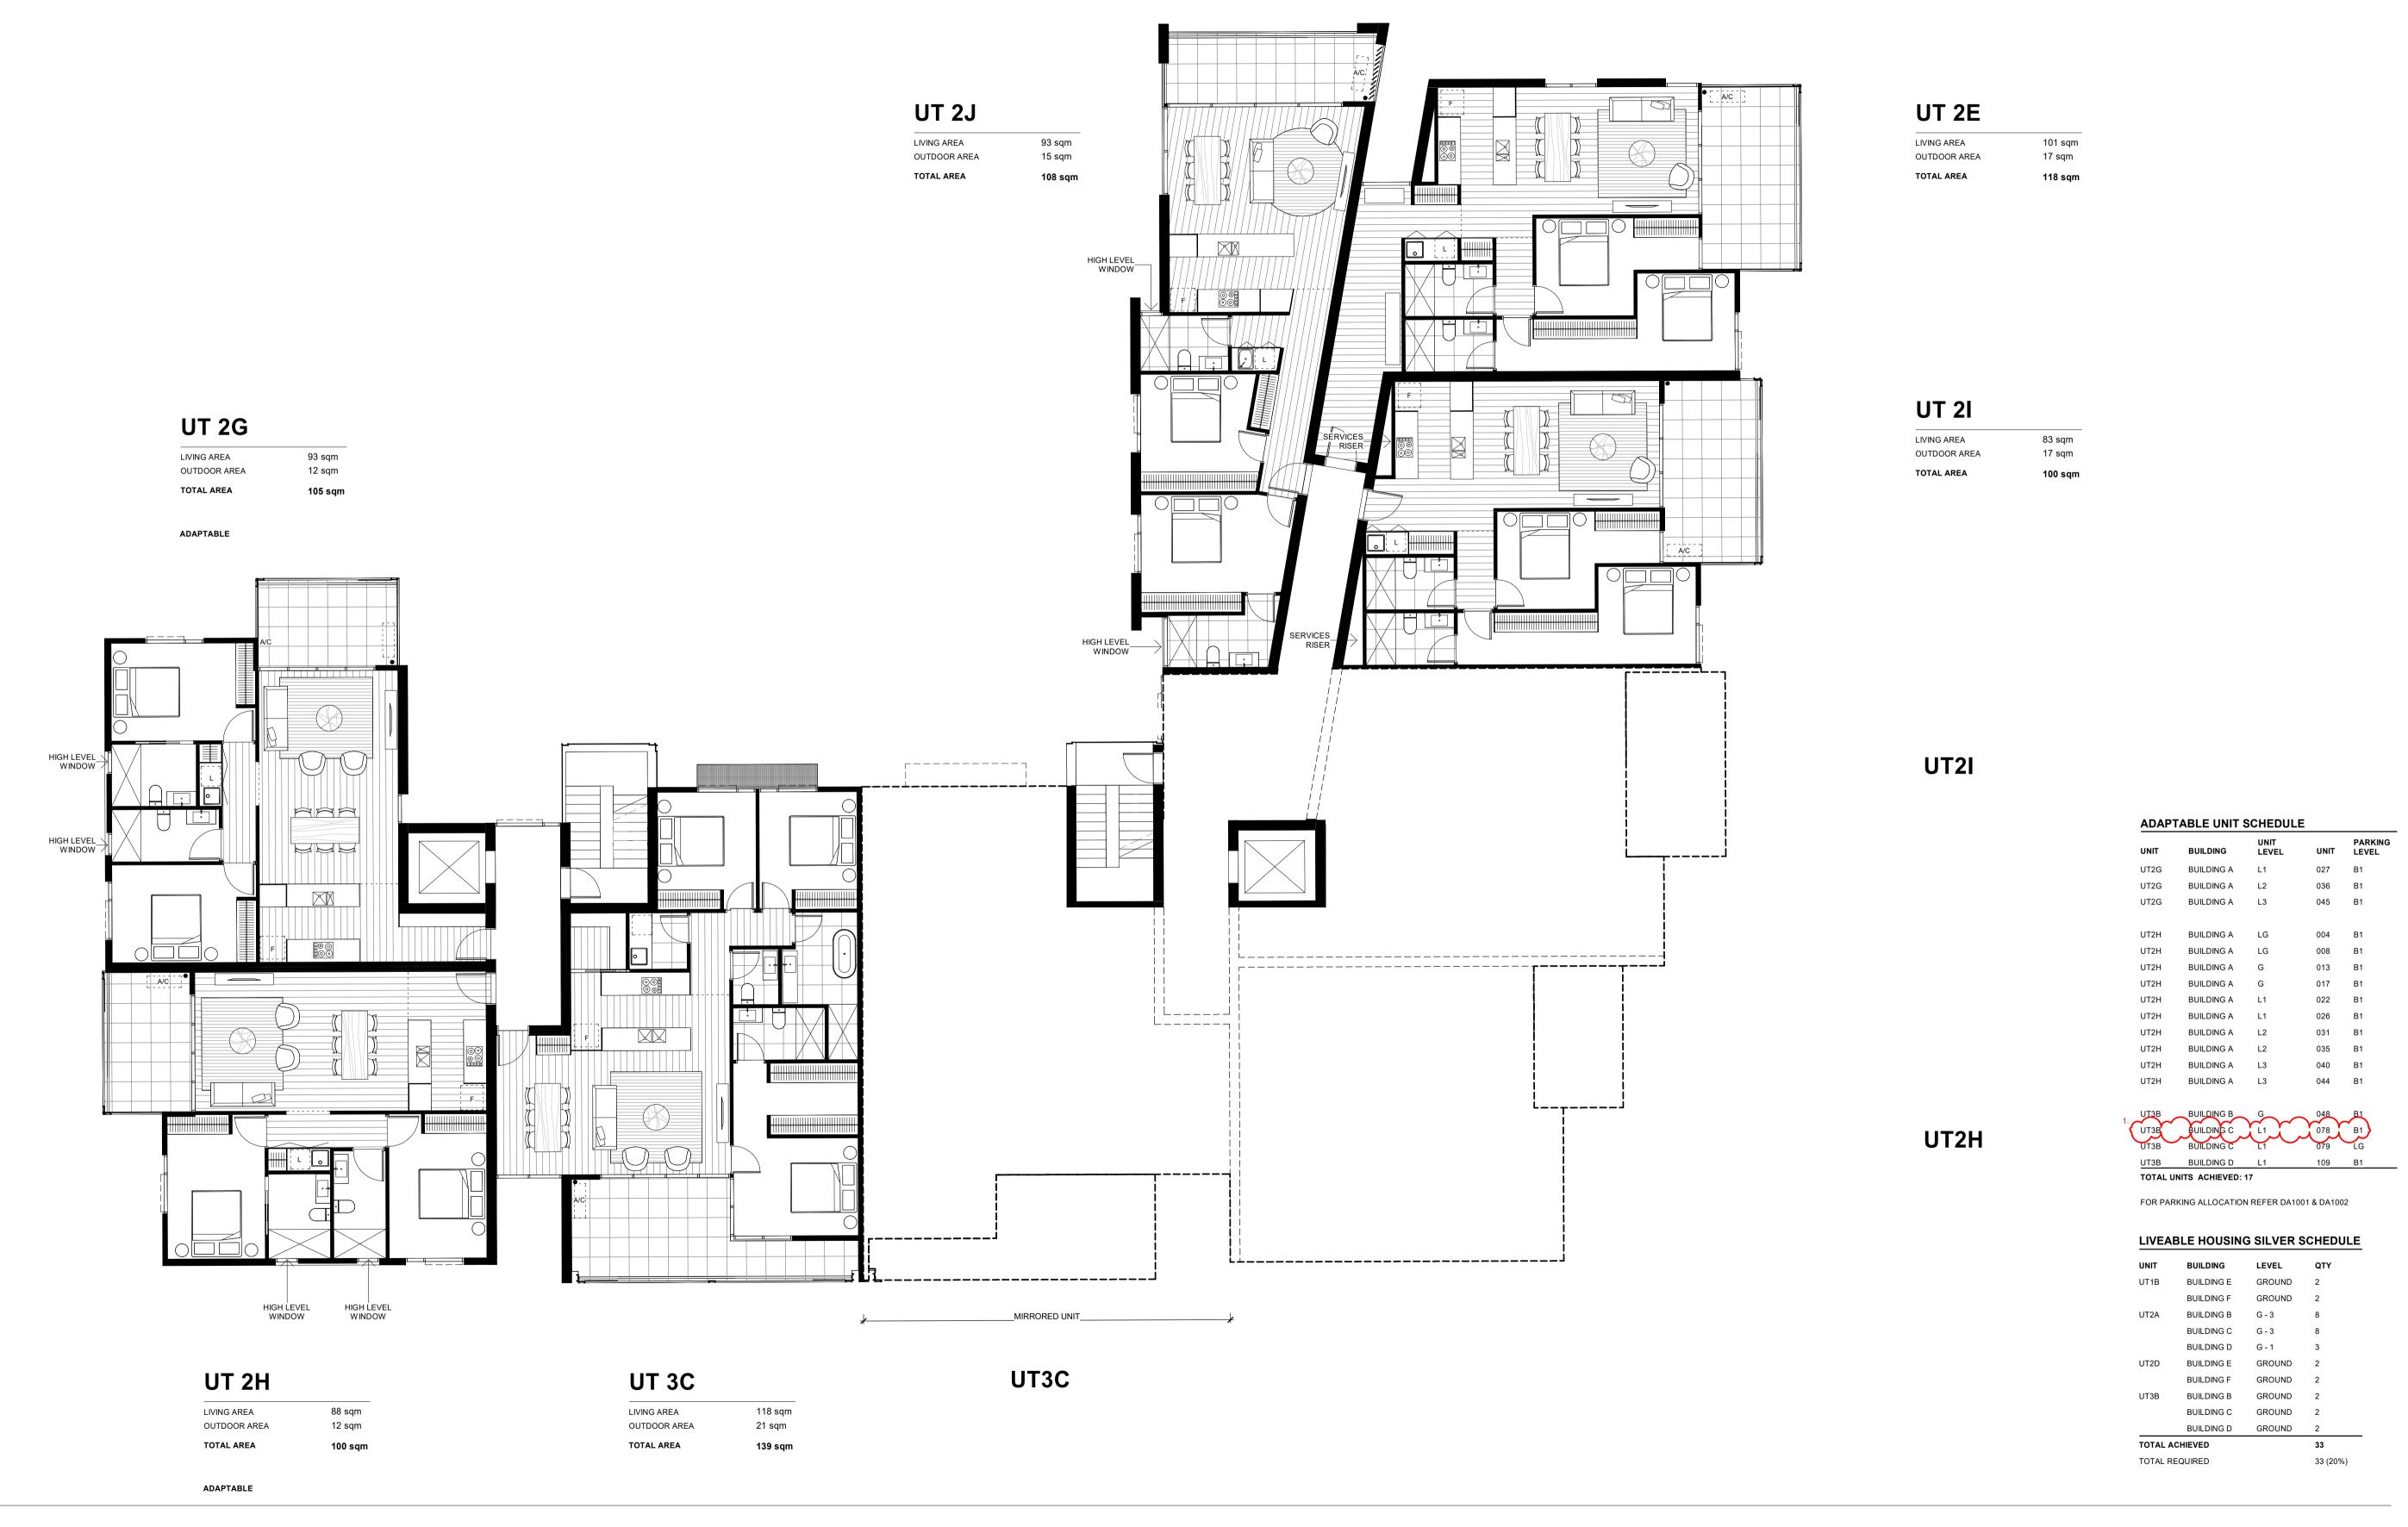

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DRAFT DEVELOPMENT APPLICATION DEVELOPMENT APPLICATION ISSUE FOR DA RFI ISSUE FOR DA RFI

10/11/2023 27/11/2023 02/07/2024 29/07/2024


PROJECT NAME GOOGONG PROJECT NUMBER **BASE DEVELOPMENTS** 2319 LOCATION


LOT 642 GOOGONG

UNIT TYPE PLANS - BUILDING A

DRAWING NUMBER **DA4001**

1. ADAPTABLE UNIT UT049 REPLACED WITH UT078

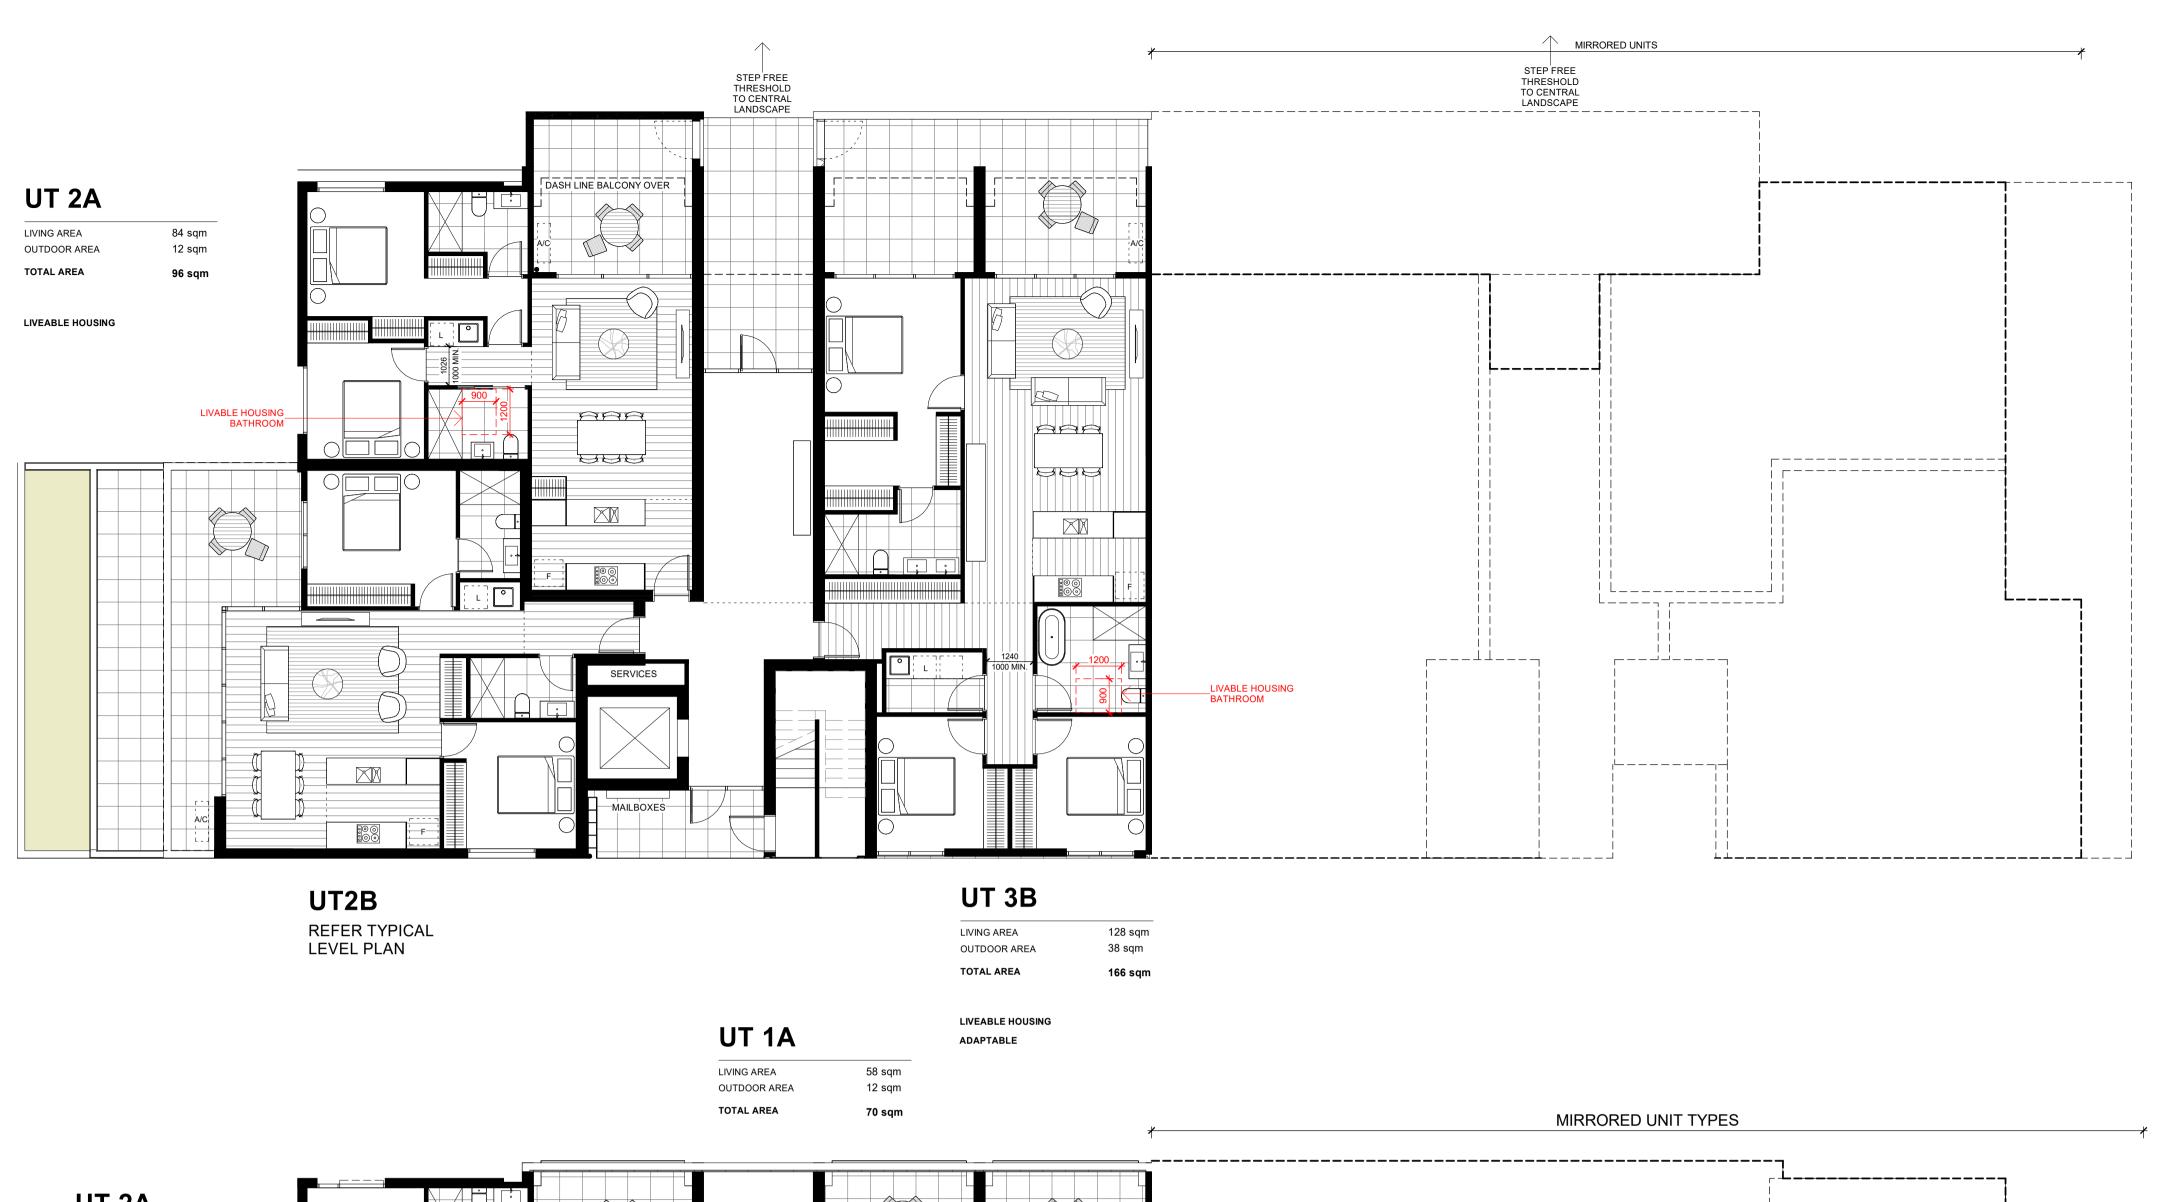

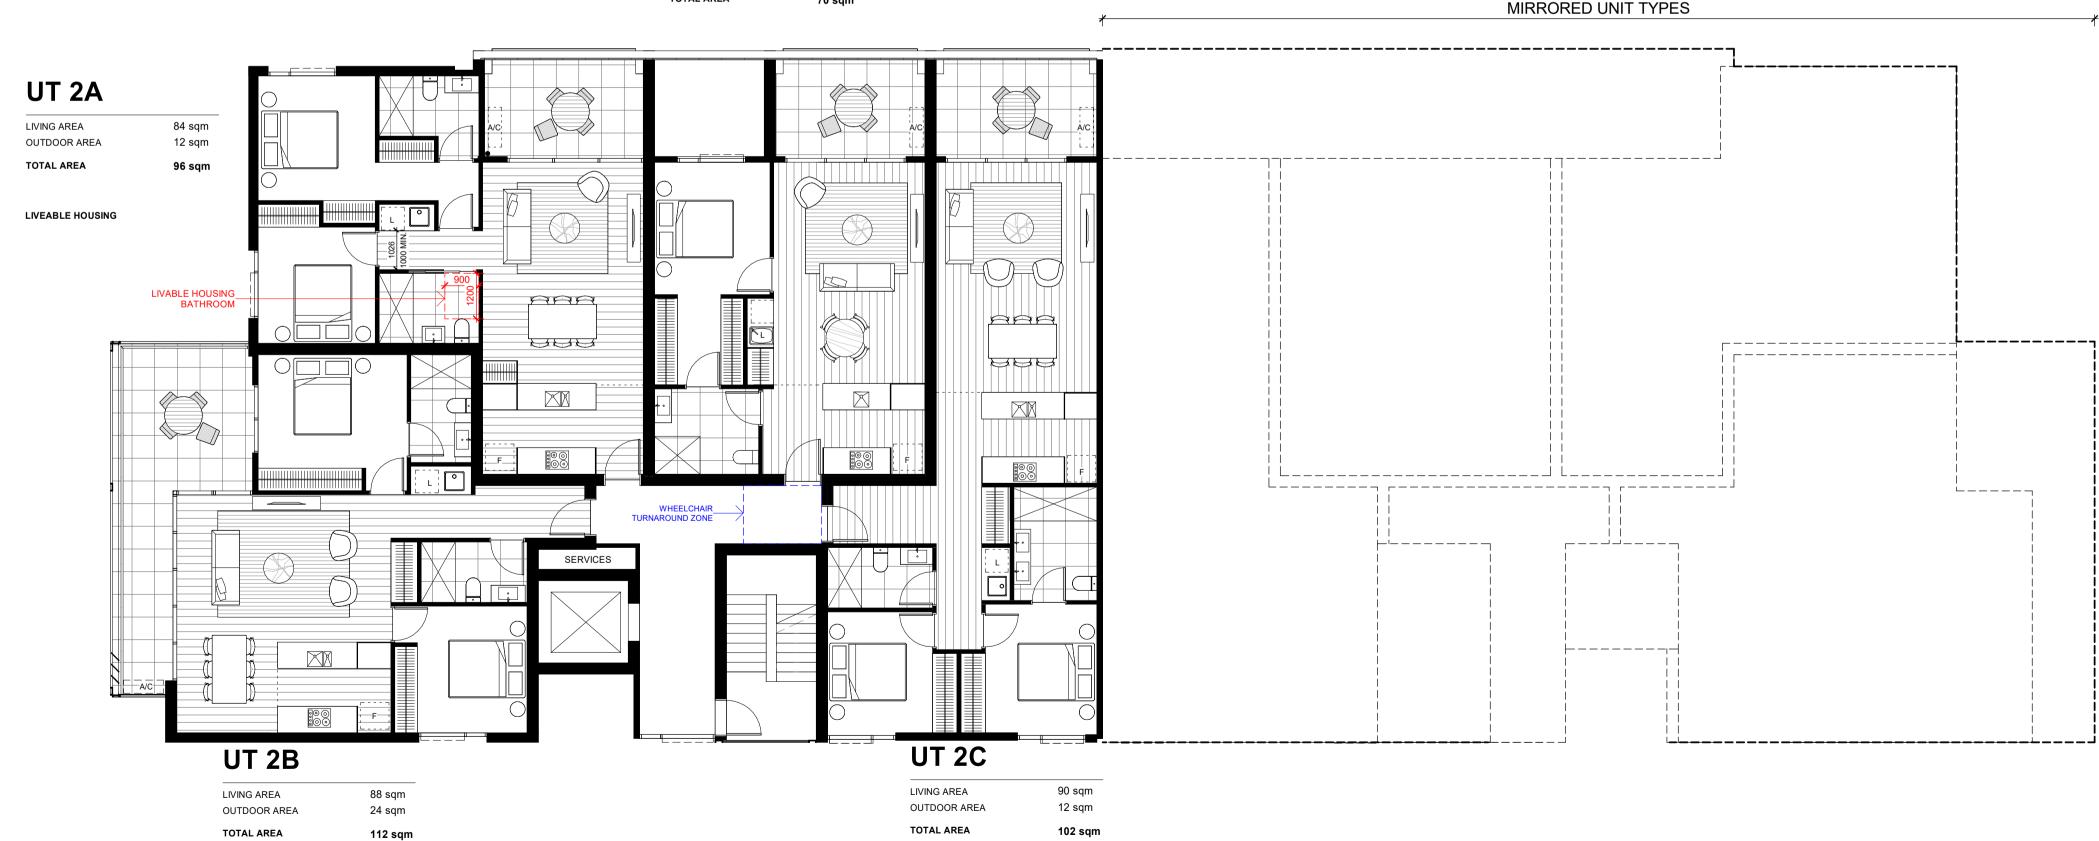

UT2H	BUILDING A	G	013	B1
UT2H	BUILDING A	G	017	B1
UT2H	BUILDING A	L1	022	B1
UT2H	BUILDING A	L1	026	B1
UT2H	BUILDING A	L2	031	B1
UT2H	BUILDING A	L2	035	B1
UT2H	BUILDING A	L3	040	B1
UT2H	BUILDING A	L3	044	B1
UT3B	BUILDING B	G	048	B1
UТ3В	BUILDING C		078	B1
UТ3В	BUILDING C	L1 U	079	LG
<u> UТЗВ</u>	BUILDING D	L1	109	B1
TOTAL U	NITS ACHIEVED:	17		
FOR PAR	RKING ALLOCATIO	N REFER DA100	01 & DA100)2
	RKING ALLOCATION			
LIVEA	BLE HOUSING	G SILVER S	CHEDI	
LIVEAI	BLE HOUSING	G SILVER S	CHED!	
LIVEAI	BLE HOUSING BUILDING E	G SILVER S	QTY 2	
LIVEAI UNIT UT1B	BLE HOUSING BUILDING E BUILDING F	G SILVER S LEVEL GROUND GROUND	QTY 2 2	
LIVEAI UNIT UT1B	BLE HOUSING BUILDING E BUILDING F BUILDING B	G SILVER S LEVEL GROUND GROUND G-3	QTY 2 2 8	
LIVEAI UNIT UT1B	BLE HOUSING BUILDING E BUILDING F BUILDING B BUILDING C	G SILVER S LEVEL GROUND GROUND G - 3 G - 3	QTY 2 2 8 8	
UNIT UT1B UT2A	BLE HOUSING BUILDING E BUILDING F BUILDING B BUILDING C BUILDING D	G SILVER S LEVEL GROUND GROUND G - 3 G - 3 G - 1	QTY 2 2 8 8 3	
UNIT UT1B UT2A	BLE HOUSING BUILDING E BUILDING F BUILDING B BUILDING C BUILDING D BUILDING E	G SILVER S LEVEL GROUND GROUND G - 3 G - 3 G - 1 GROUND	QTY 2 2 8 8 3 2	
UNIT UT1B UT2A UT2D	BLE HOUSING BUILDING E BUILDING F BUILDING B BUILDING C BUILDING D BUILDING E BUILDING F	G SILVER S LEVEL GROUND GROUND G-3 G-3 G-1 GROUND GROUND	QTY 2 2 8 8 3 2 2	
UNIT UT1B UT2A UT2D	BLE HOUSING BUILDING E BUILDING F BUILDING C BUILDING D BUILDING E BUILDING E BUILDING F BUILDING F BUILDING F	G SILVER S LEVEL GROUND GROUND G - 3 G - 3 G - 1 GROUND GROUND GROUND	QTY 2 2 8 8 3 2 2 2	

33 (20%)

ADAPTABLE UNIT SCHEDULE

REV	DESCRIPTION
Δ	DRAFT DEVELOPMENT APPLICATION
B	DEVELOPMENT APPLICATION
C	ISSUE FOR DA RFI
D	ISSUE FOR DA RFI
	A B C

DATE
10/11/2023
27/11/2023
02/07/2024
29/07/2024


LOT 642 GOOGONG

TOTAL REQUIRED


TYPICAL LEVELS

1. ADAPTABLE UNIT UT049 REPLACED WITH UT078

GROUND

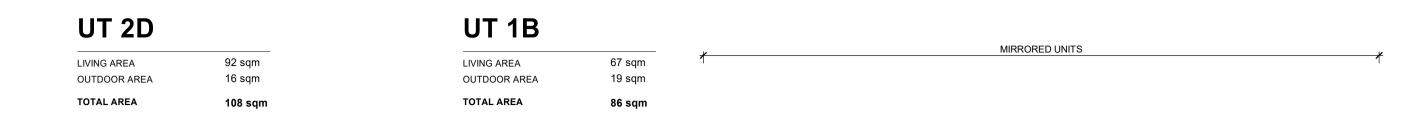

LIVEABLE HOUSING

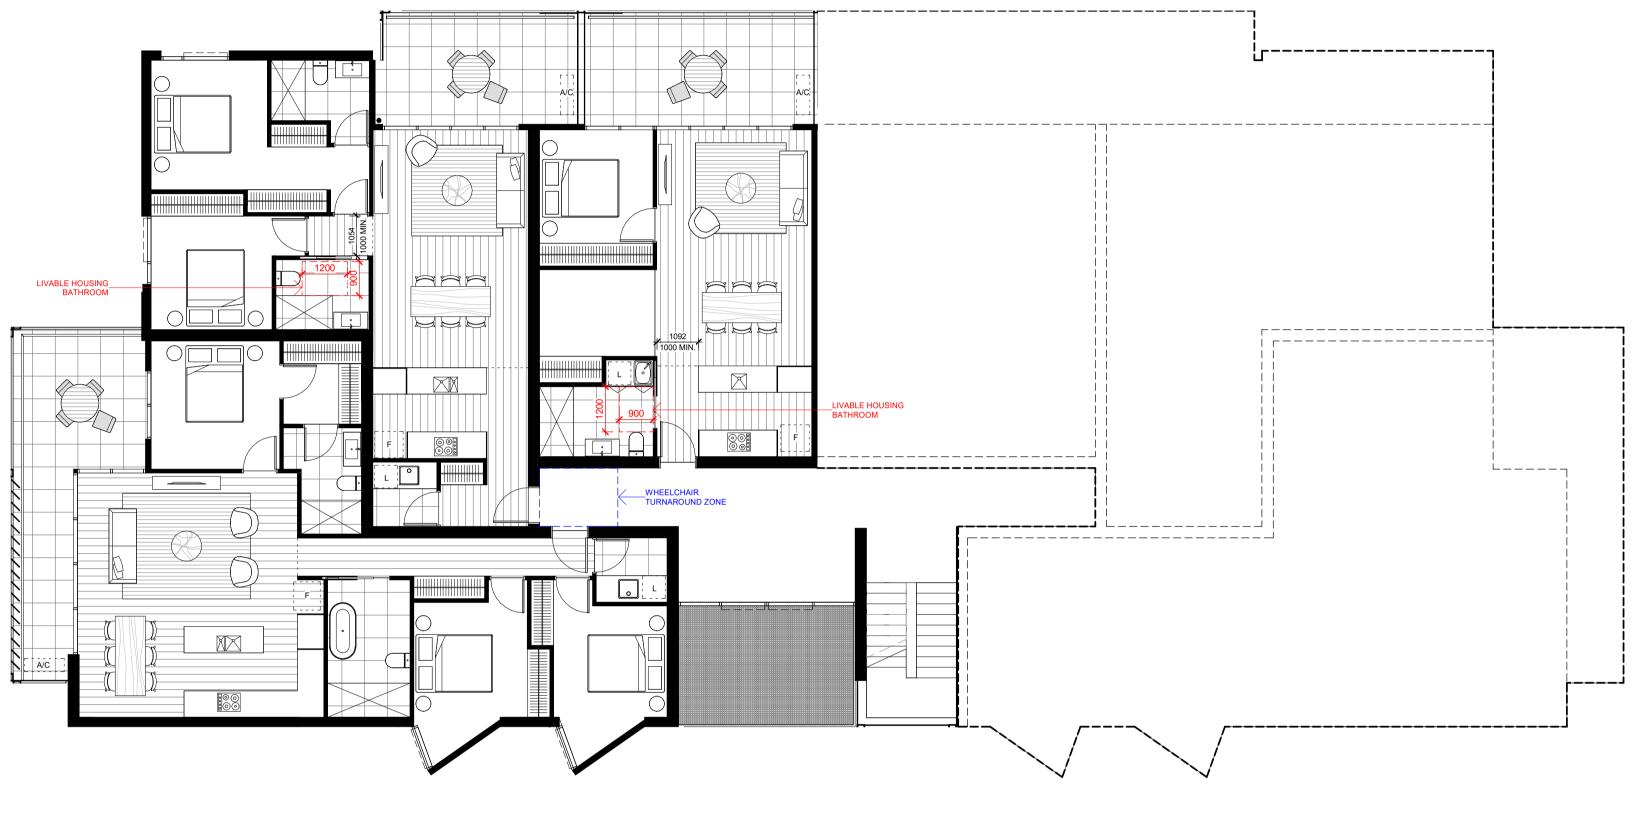

UT 3A	
LIVING AREA	118 sqm
OUTDOOR AREA	24 sqm
TOTAL AREA	142 sgm

LIVEABLE HOUSING

UNIT	BUILDING	UNIT LEVEL	UNIT	PARK LEVE
UT2G	BUILDING A	L1	027	B1
UT2G	BUILDING A	L2	036	B1
UT2G	BUILDING A	L3	045	B1
UT2H	BUILDING A	LG	004	В1
UT2H	BUILDING A	LG	800	B1
UT2H	BUILDING A	G	013	В1
UT2H	BUILDING A	G	017	B1
UT2H	BUILDING A	L1	022	B1
UT2H	BUILDING A	L1	026	B1
UT2H	BUILDING A	L2	031	B1
UT2H	BUILDING A	L2	035	B1
UT2H	BUILDING A	L3	040	В1
UT2H	BUILDING A	L3	044	В1



TOTAL UNITS ACHIEVED: 17

FOR PARKING ALLOCATION REFER DA1001 & DA1002

LIVEABLE HOUSING SILVER SCHEDULE			
UNIT	BUILDING	LEVEL	QTY
UT1B	BUILDING E	GROUND	2
	BUILDING F	GROUND	2
UT2A	BUILDING B	G - 3	8
	BUILDING C	G - 3	8
	BUILDING D	G - 1	3
UT2D	BUILDING E	GROUND	2
	BUILDING F	GROUND	2
UT3B	BUILDING B	GROUND	2

BUILDING F GROUND 2

UT3B BUILDING B GROUND 2

BUILDING C GROUND 2

BUILDING D GROUND 2

TOTAL ACHIEVED 33

TOTAL REQUIRED 33 (20%)


DA4003
REVISION

DRAWING NUMBER


LOT 642 GOOGONG

UNIT TYPE PLANS - BUILDING E & F

1. ADAPTABLE UNIT UT049 REPLACED WITH UT078

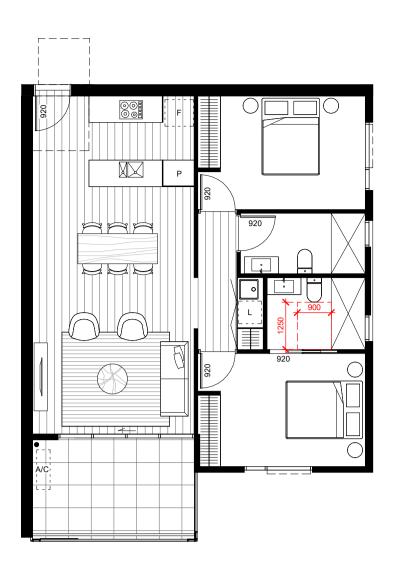

UNIT TYPE 2H - PRE-ADAPTABLE

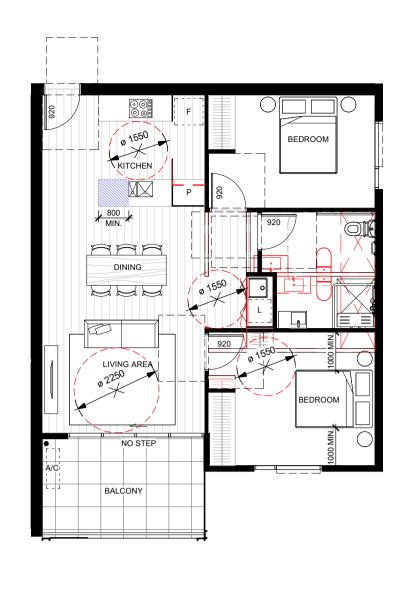



UNIT TYPE 2H - POST-ADAPTABLE

PPP

DINING

NO STEP

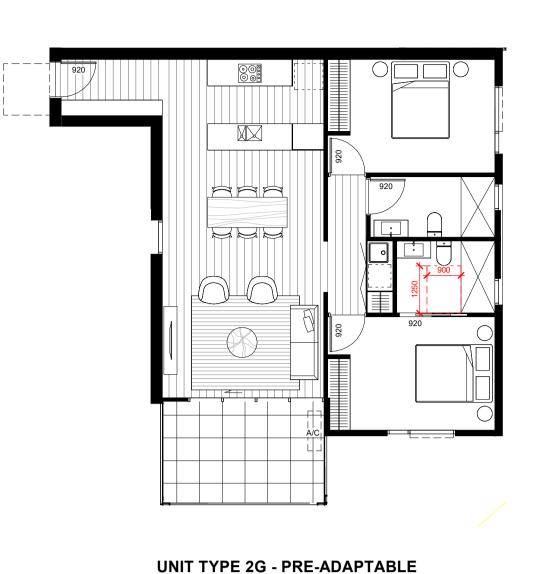

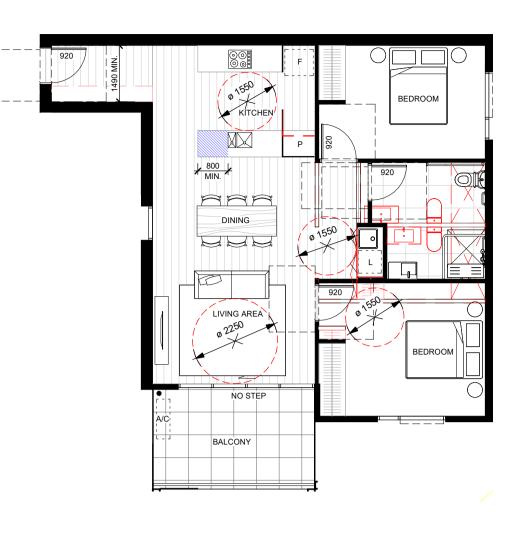

UNIT TYPE 2G - POST-ADAPTABLE

BUILDING D

ADAPTABLE UNIT SCHEDULE

036 B1

035 B1

BUILDING A

BUILDING A

BUILDING A BUILDING A

UT2G

UT2H

UT2H

UT2H

UT2H

UT2H

UT2H

UT2H

FOR PARKING ALLOCATION REFER DA1001 & DA1002

ADAPTABLE NOTES

TOTAL UNITS ACHIEVED: 17

GENERALLY

•SWITCHES LOCATED AT 900 - 1100 ABOVE FLOOR AND IN LINE WITH DOOR HANDLES

•GPO ADJACENT TO TELEPHONE
•GPO'S LOCATED NO LOWER THAN 300mm ABOVE FLOOR

UNLESS NOTED OTHERWISE •ENTRY DOOR HANDLES & HARDWARE TO AS1428.2
•DOOR HARDWARE TO BE OPERABLE WITH ONE HAND AND LOCATED 900-1100 ABOVE FFL

•ALL DOORS TO HAVE 850mm MIN CLEARANCE

CORRIDORS MIN WIDTH OF 1200mm (UNLESS NOTED OTHERWISE) COMPLIANCE WITH AS1428.1 FOR DOOR APPROACHES

BATHROOMS •BATHROOM WATERPROOFED TO AS3740 •PROVIDE RECESSED SOAP HOLDER

•POSITION SHOWER MIXER AS PER AS1428.1 •POSITION SHOWER MIXER BETWEEN 900 AND 1100mm ABOVE THE FINISHED FLOOR LEVEL •SHOWER RAIL TO BE 580-600mm FROM CORNER OF SHOWER, WITH LOCATED BELOW THE RAIL AT 700mm ABOVE THE FINISHED FLOOR

•PROVIDE REINFORCED AREAS TO WALLS FOR INSTALLATION OF GRAB RAILS TO SHOWER AND WC TO AS1428.1 •LEVER MIXER TO BASIN
•SLIP RESISTANT FLOOR TO AS/NZS3661.1

 PROVIDE ONE DOUBLE GPO LOCATED BESIDE MIR •SHOWER WASTE MIN DIAMETER 80mm •BASIN, W/C, GRAB RAILS & FOLDING SHOWER SEAT TO COMPLY WITH AS1428.1

•PROVIDE SHOWER CURTAIN AND RAIL

LAUNDRY

PROVIDE DOUBLE GPO
SLIP RESISTANT FLOOR TO AS/NZS 3661.1
INSTALLATION OF THERMOSTATIC MIXING VALVES PROVIDE 1550mm CLEAR IN FRONT OF WASHING MACHINE
 TUB MIXER TO FRONT OF TUB

KITCHEN

1 DOUBLE GPO WITHIN 300mm OF FRONT OF WORK SURFACE
SLIP RESISTANT FLOOR TO AS/NZS3661.1
RAISED CROSS BAR TO CONTROLS
ISOLATING SWITCH TO COOKTOP
REFRIGERATOR ADJACENT WORK SURFACE
GPO FOR REFRIGERATOR TO BE EASILY WITHIN REACH INSTALLATION OF THERMOSTATIC MIXING VALVES
 LOCATE HANDLES TOWARDS THE TOP OF UNDER-BENCH CUPBOARDS AND TO THE BOTTOM OF OVER-BENCH CUPBOARDS

•PROVIDE SPACE FOR MICROWAVE IN OVER-BENCH CUPBOARD

POTENTIAL ILLUMINATION TO BE MIN 300LUX
 PROVISION FOR CIRCULATION SPACE OF MIN 2250mm DIAMETER

•MIN 4 DOUBLE GPOS

•MIN 1000mm UNOBSTRUCTED SPACE ALONG 1 SIDE OF BED •PROVISION FOR CIRCULATION SPACE OF MIN 1540mm X 2070 IN DIRECTION OF TRAVEL

MIN 2 DOUBLE GPOS

EXTERIOR

•SLIP RESISTANT FLOOR TO AS/NZS3661.1
•MAX 5mm STEP BETWEEN EXTERNAL FLOORING AND INTERNAL FLOORING AND TO FULL WIDTH OF DOOR OPENING

NOTE: ADAPTABLE UNIT TO MEET AS4299-2009 ON COMPLETION ALL DIMENSION TO STUD WALL


ADAPTABLE LEGEND



OFFLOAD ZONE



PROVISIONAL PLUMBING POINT

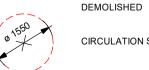

CIRCULATION SPACE

WALLS/JOINERY

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AWNING OVER

UNIT TYPE 3B - PRE-ADAPTABLE

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DRAFT DEVELOPMENT APPLICATION DEVELOPMENT APPLICATION ISSUE FOR DA RFI ISSUE FOR DA RFI

10/11/2023 27/11/2023 02/07/2024 29/07/2024 PROJECT NAME GOOGONG PROJECT NUMBER 2319

BASE DEVELOPMENTS

UNIT TYPE PLANS - ADAPTABLE

DA4004 REVISION

DRAWING NUMBER


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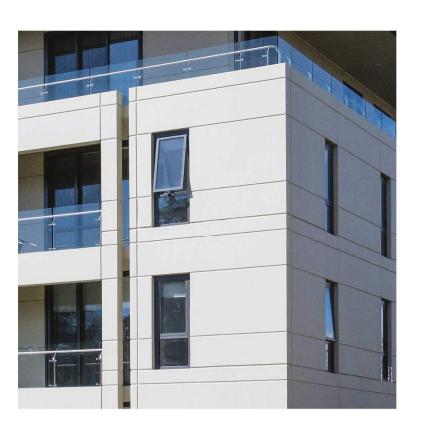
1. ADAPTABLE UNIT UT049 REPLACED WITH UT078

UNIT TYPE 3B - POST-ADAPTABLE



PC1
WALL
CONCRETE
OFF WHITE
TEXTURED FINISH




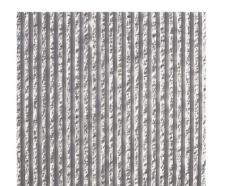









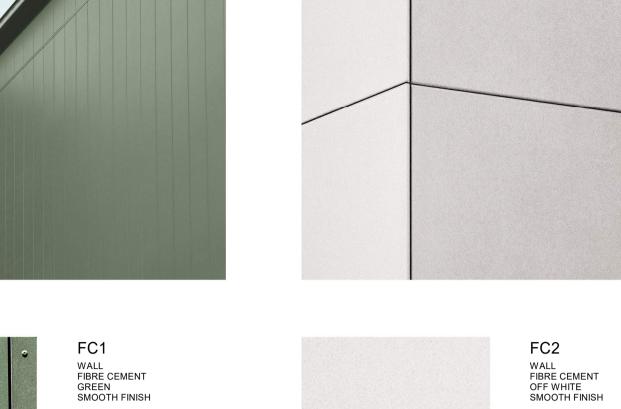

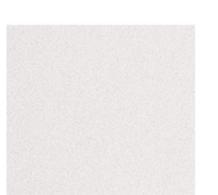




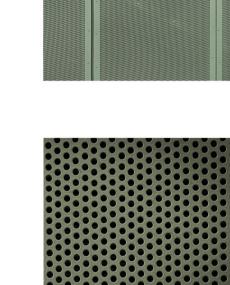

SC1 SCREEN METAL GREEN PERFORATED



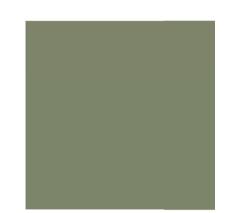











STEELWORK METAL GREEN / BLACK

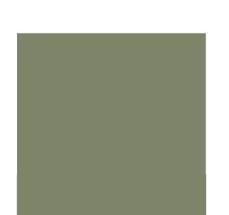



WINDOW FRAME ALUMINIUM DARK GREY



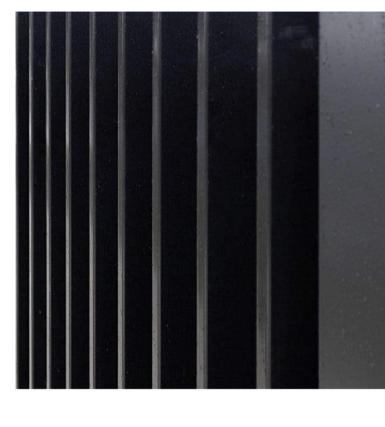

FE1 / GA1

FENCE / GATE ALUMINIUM PALISADE DARK GREY

FC3
WALL
FIBRE CEMENT
GREEN
SMOOTH FINISH









CW1 WALL MASONRY OFF-WHITE STONE FACE FINISH





LOT 642 GOOGONG

10/11/2023


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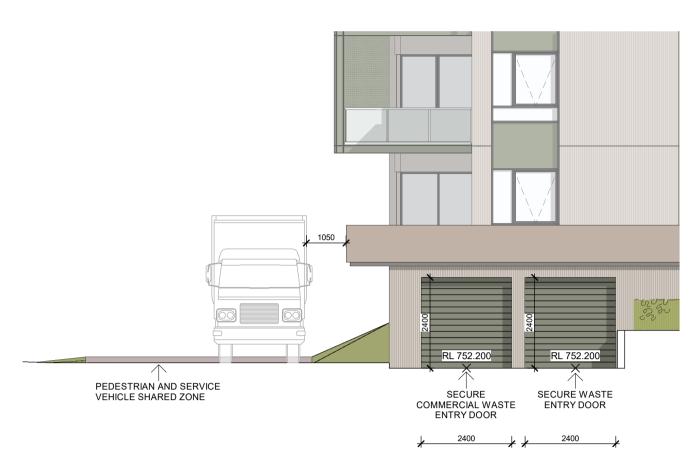
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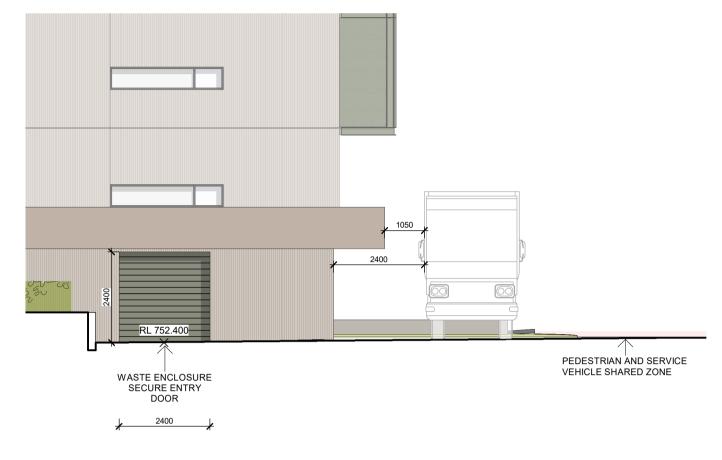
REVISION

DA5001

StewartArchitecture






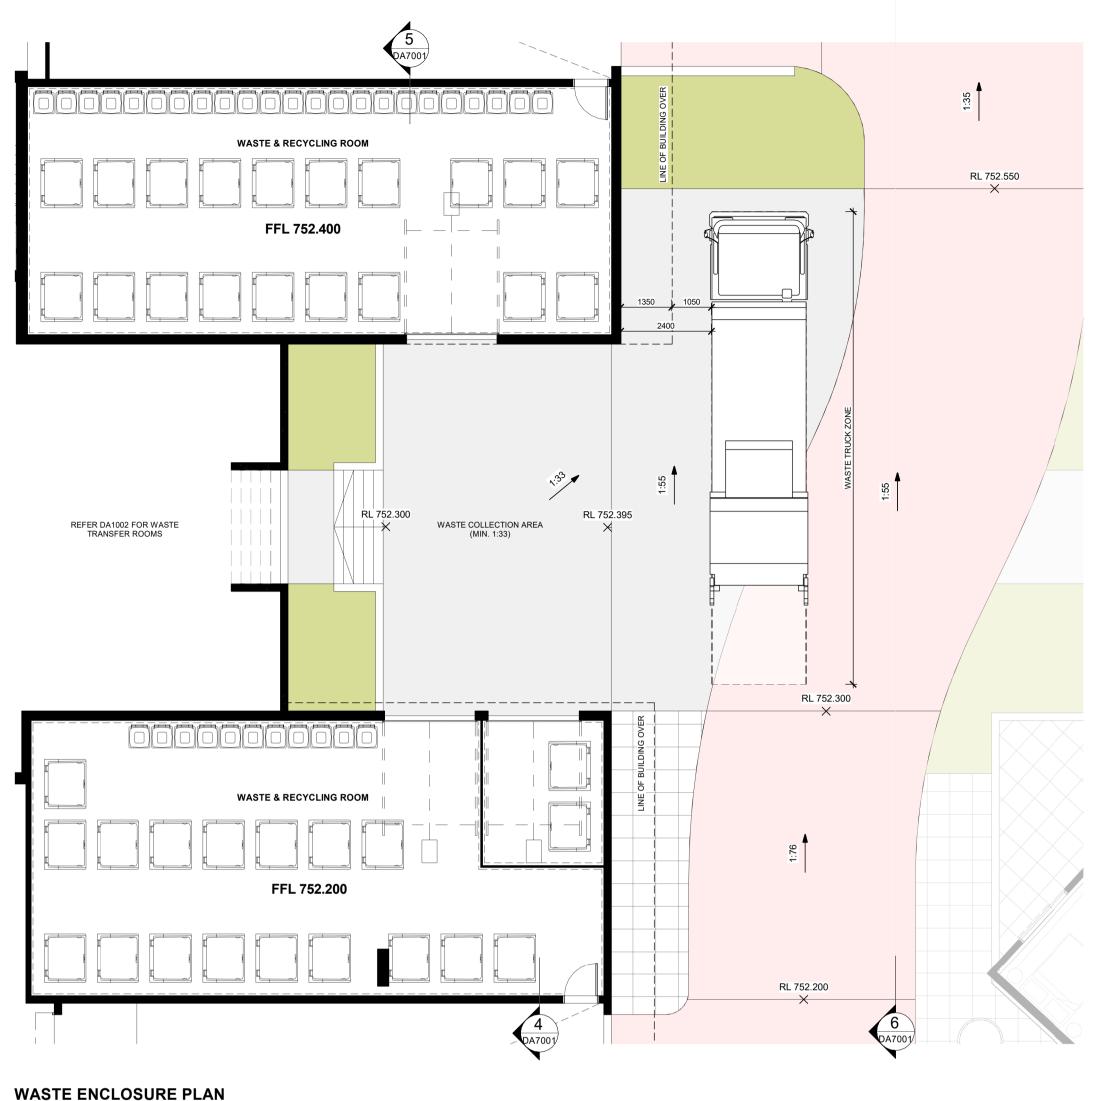

WASTE ENCLOSURE ELEVATION EAST

WASTE ENCLOSURE ELEVATION NORTH



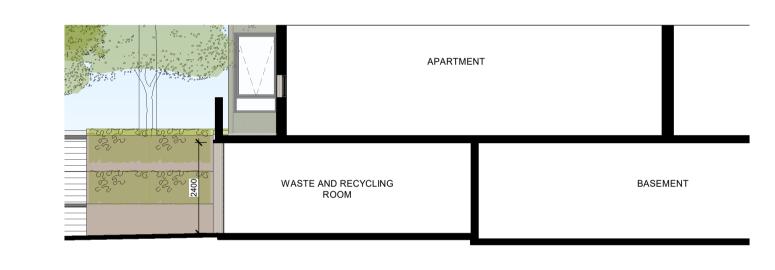

WASTE ENCLOSURE SECTION 1

WASTE ENCLOSURE SECTION 2





10/11/2023

27/11/2023

DA7001 1:100 @ A1

DRAWING NUMBER

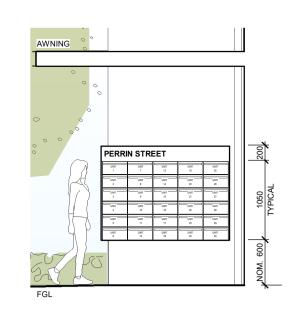

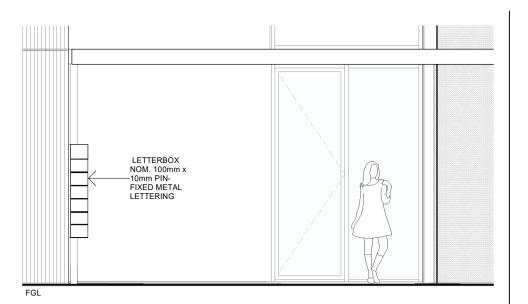


MAILBOX - ELEVATION 1

TYPICAL MAILBOX FOR BUILDINGS A, B, C & D


MAILBOX - SECTION 1

TYPICAL MAILBOX FOR BUILDINGS A, B, C & D

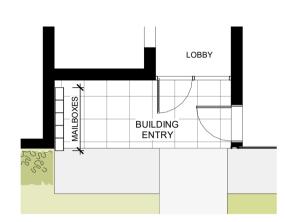

MAILBOX - PLAN 1

TYPICAL MAILBOX FOR BUILDINGS A, B, C & D

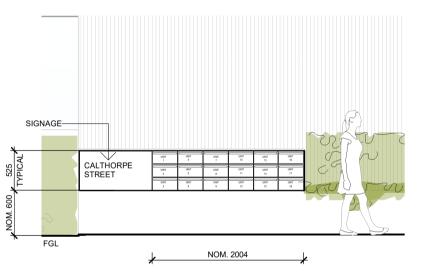




MAILBOX - ELEVATION 2 TYPICAL MAILBOX FOR BUILDINGS E & F



MAILBOX - SECTION 2

TYPICAL MAILBOX FOR BUILDINGS E & F

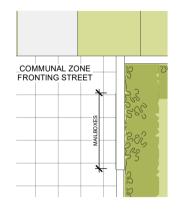

MAILBOX - PLAN 2

TYPICAL MAILBOX FOR BUILDINGS E & F

COURTYARD WALL AND FENCING NOTES


COURTYARD WALL SANDSTONE FACE FINISH METAL PALISADE; DARK GREY METAL PALISADE; DARK GREY FENCE GATE SCREEN PERFORATED METAL; BLACK

FENCING TYPE 1 PPOS FENCING TYPE 2 SECONDARY OPEN SPACE FENCING TYPE 3 PPOS 50% FRONT SETBACK HEIGHT AT 1-1.2m / 50% at HEIGHT 1.5m MAX 1.2m HEIGHT FROM INTERNAL LEVEL ALTERNATE FENCING REQUIRED FRONTING SHARED DRIVEWAY


REFER TO DA0115 MASTER PLAN FOR FENCING LOCATION TO GROUND FLOOR UNITS REFER TO DA5001 MATERIALS & FINISHES FOR FE1 AND GA1 SPECIFICATIONS




TYPICAL RESIDENTIAL INTERFACE (BUILDING A) -**FENCING TYPE 1**

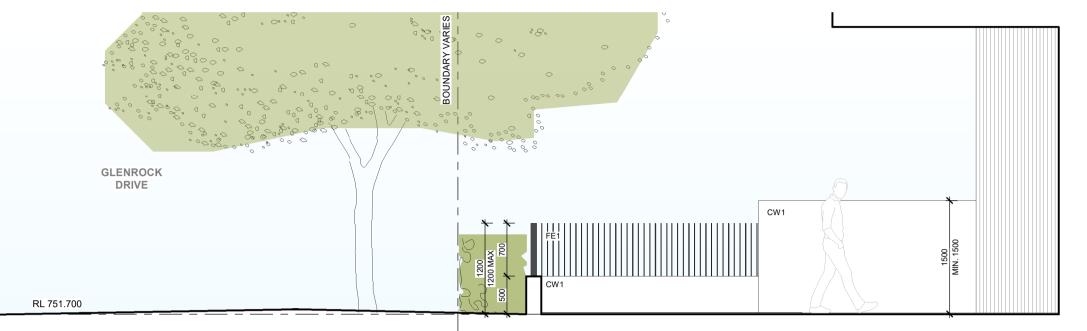


TYPICAL COMMERCIAL ADAPTIVE INTERFACE (BUILDING A) - FENCING TYPE 1

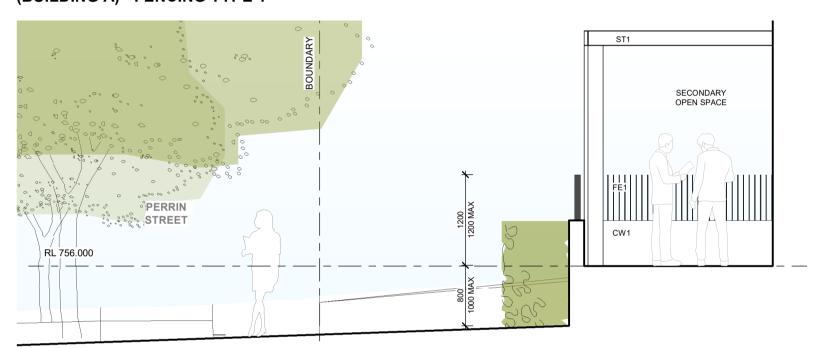


TYPICAL RESIDENTIAL INTERFACE (BUILDING B) -**FENCING TYPE 2**

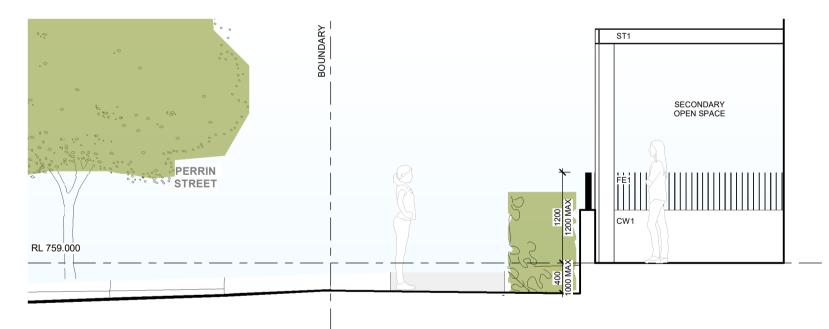


TYPICAL RESIDENTIAL INTERFACE (BUILDING C) -**FENCING TYPE 2**

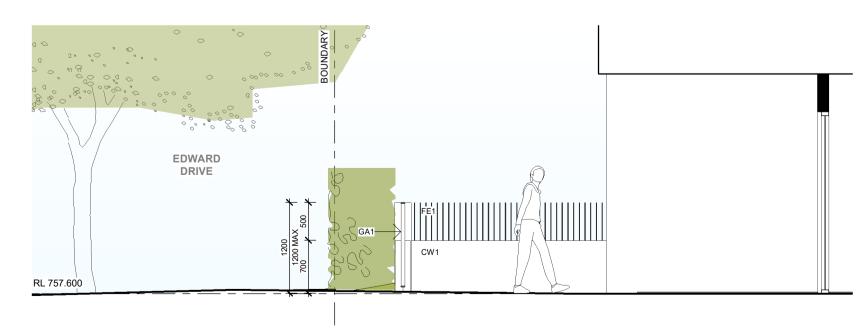


TYPICAL RESIDENTIAL INTERFACE (BUILDING D) -**FENCING TYPE 1**

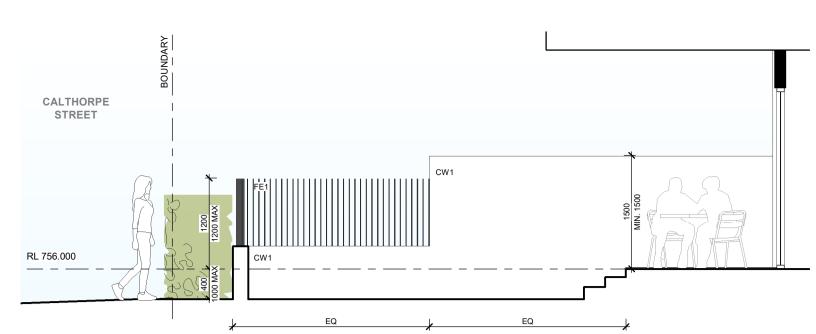


TYPICAL RESIDENTIAL INTERFACE (BUILDING E) -

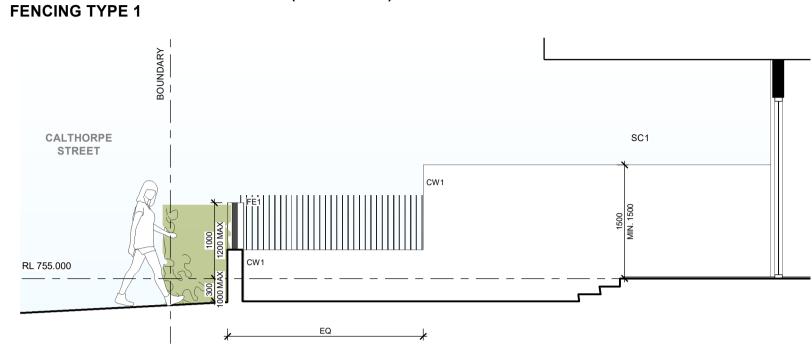


TYPICAL RESIDENTIAL INTERFACE (BUILDING F) -**FENCING TYPE 1**

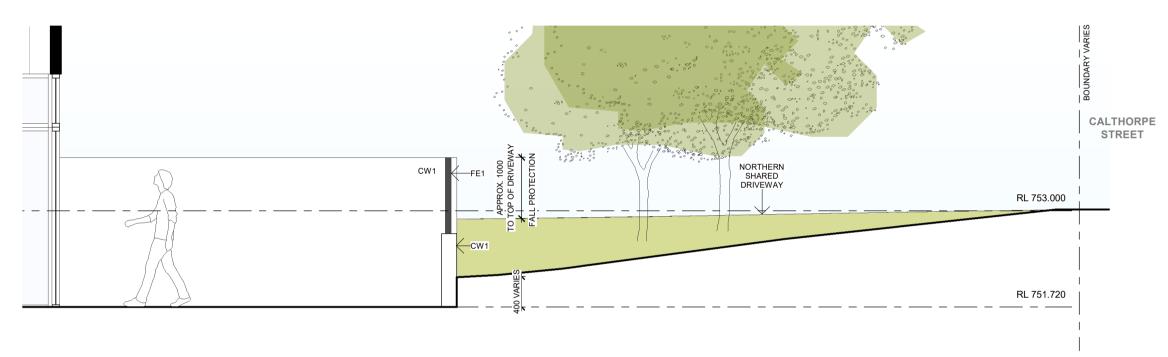

UT2J TO CALTHORPE STREET (BUILDING A) -**FENCING TYPE 3**

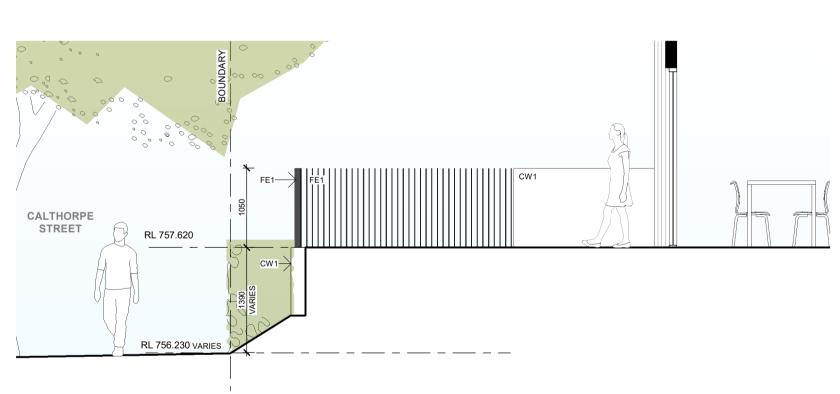

UT2B TO CALTHORPE STREET (BUILDING D) -**FENCING TYPE 1**

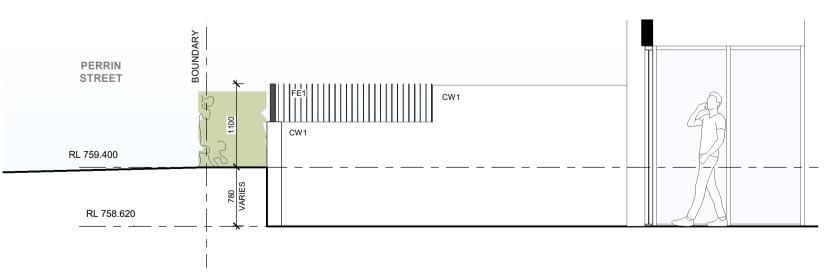

UT2B TO PERRIN STREET (BUILDING D) - FENCING


TYPE 1

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LOT 642 GOOGONG


10/11/2023

27/11/2023

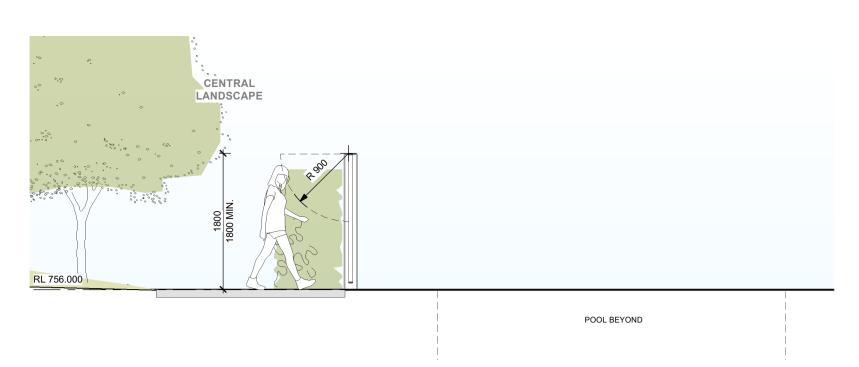


POOL GATE - TYPICAL SECTION

POOL GATE TO COMPY WITH AS 1926.1

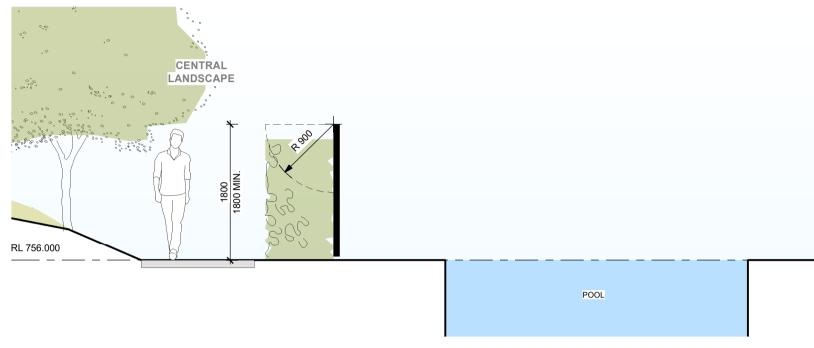


POOL FENCE - TYPICAL SECTION

POOL FENCING TO COMPY WITH AS 1926.1

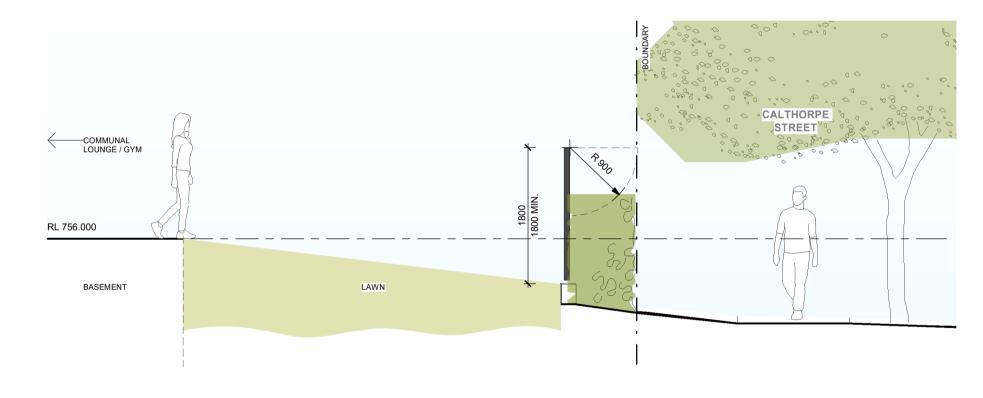


POOL FENCE - TYPICAL SECTION - COMMUNAL

LOUNGE POOL FENCING TO COMPY WITH AS 1926.1

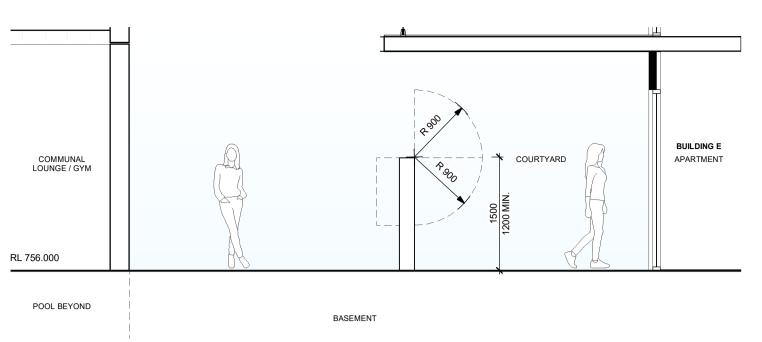

POOL / LOUNGE INTERFACE TO APARTMENT -**SECTION 1**

POOL GATE TO COMPY WITH AS 1926.1

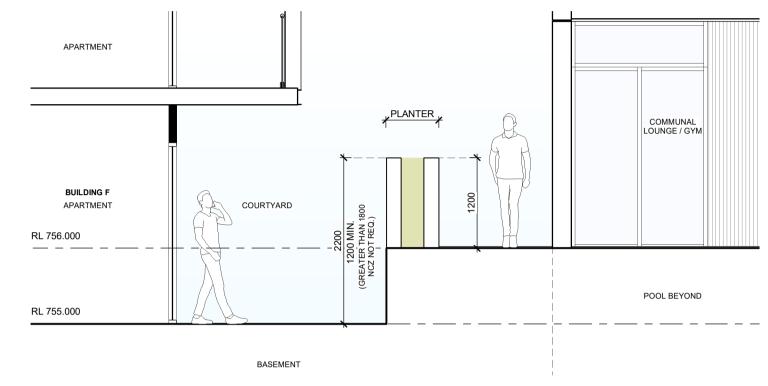

POOL / LOUNGE INTERFACE TO APARTMENT -

SECTION 2 POOL GATE TO COMPY WITH AS 1926.1

20. BUILDING MATTERS

LOT 642 GOOGONG